


1 DEMO HOLDING CELL FLOOR PLAN

SCALE: 3/8"=1'-0"

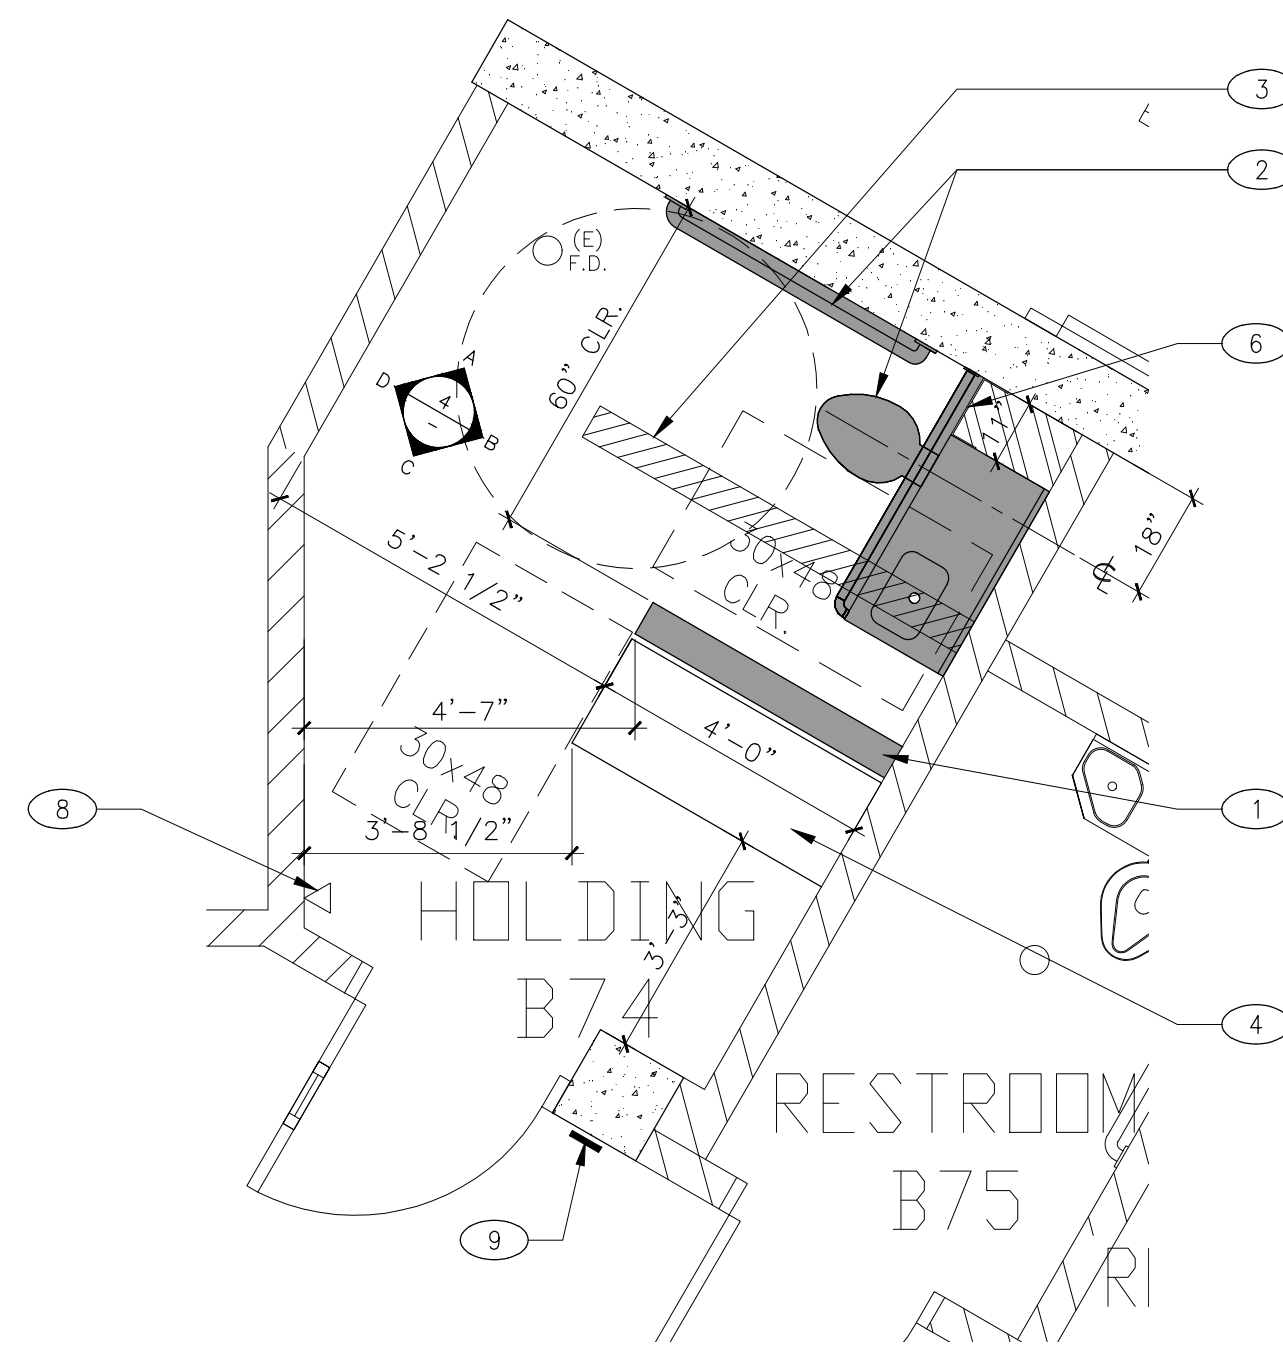

2 NEW HOLDING CELL FLOOR PLAN

SCALE: 3/8"=1'-0"

PLAN & ELEVATION NOTES

- COORDINATE DEMOLITION WITH NEW CONSTRUCTION DRAWINGS FOR DEMOLITION, SALVAGE, PROTECTION AND RESTORATION OF (E) ITEMS. CONTRACTOR SHALL VERIFY (E) CONDITION PRIOR TO DEMOLITION COMMENCEMENT. PROCEED WITH CAUTION TO AVOID POSSIBLE (E) UNDERGROUND UTILITY LINES, CONDUIT, PIPING, ETC.
- IF ANY DEMO OF (E) CONC. IS REQ'D, SCAN FOR UTILITIES AND REBAR PRIOR TO WORK.
- PATCH AND REPAIR DEMO WALL FINISH TO MATCH (E).
- PATCH AND REPAIR DEMO CEILING FINISH TO MATCH (E).
- PATCH AND REPAIR DEMO FLOOR FINISH TO MATCH (E).
- EXAMINE ALL FINISH SURFACES AFTER COMPLETION OF WORK AND PROCEED WITH "TOUCH-UP" AS REQUIRED.

No.	DESCRIPTION	DATE
1	SCHEMATIC DESIGN	06-15-2020
2	60% DESIGN DOCUMENTS	07-10-2020
3	95% DESIGN DOCUMENTS	08-07-2020
4	100% DESIGN DOCUMENTS	09-04-2020
5	PLAN CHECK SUBMISSION	09-28-2020




COUNTY OF MARIN, DEPARTMENT OF PUBLIC WORKS
PROJECT ACCEPTED BY:

DEMO KEYNOTES

- REMOVE (E) CMU PONY WALL, PATCH & PAINT WALL TO MATCH (E)
- REMOVE (E) WOOD BENCH & SUPPORTS @ WALL, SALVAGE STEEL PLATE @ WALL IF POSSIBLE, PATCH & PAINT WALL TO MATCH (E)
- REMOVE (E) TOILET/SINK COMBI FIXTURE, PREPARE TO RECEIVE (N) COMBI FIXTURE
- REMOVE AREA OF (E) SLAB AS REQ'D TO INSTALL (N) CMU PONY WALL & FOOTING
- (E) INTERCOM TO REMAIN


3 DEMO HOLDING CELL ELEVATIONS

SCALE: 1/4"=1'-0"

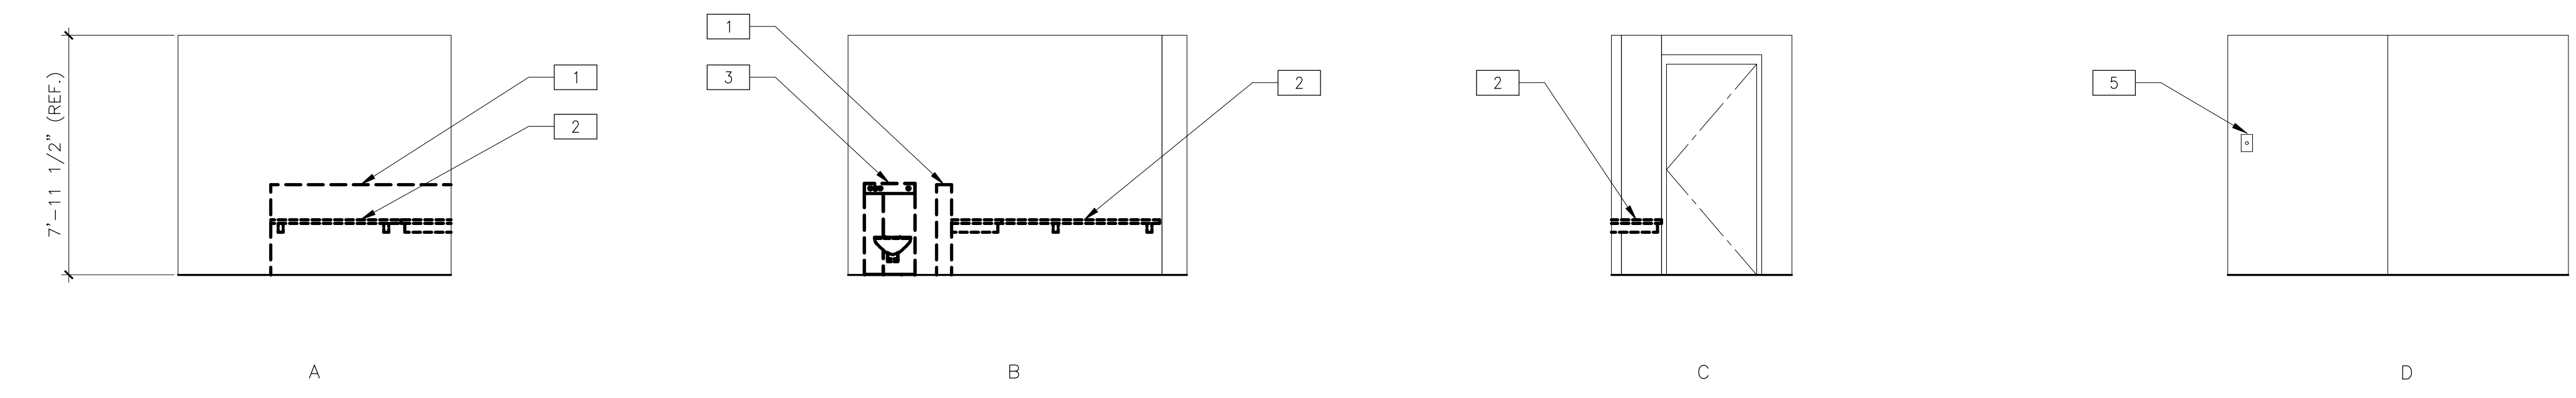


4 NEW HOLDING CELL ELEVATIONS

SCALE: 1/4"=1'-0"

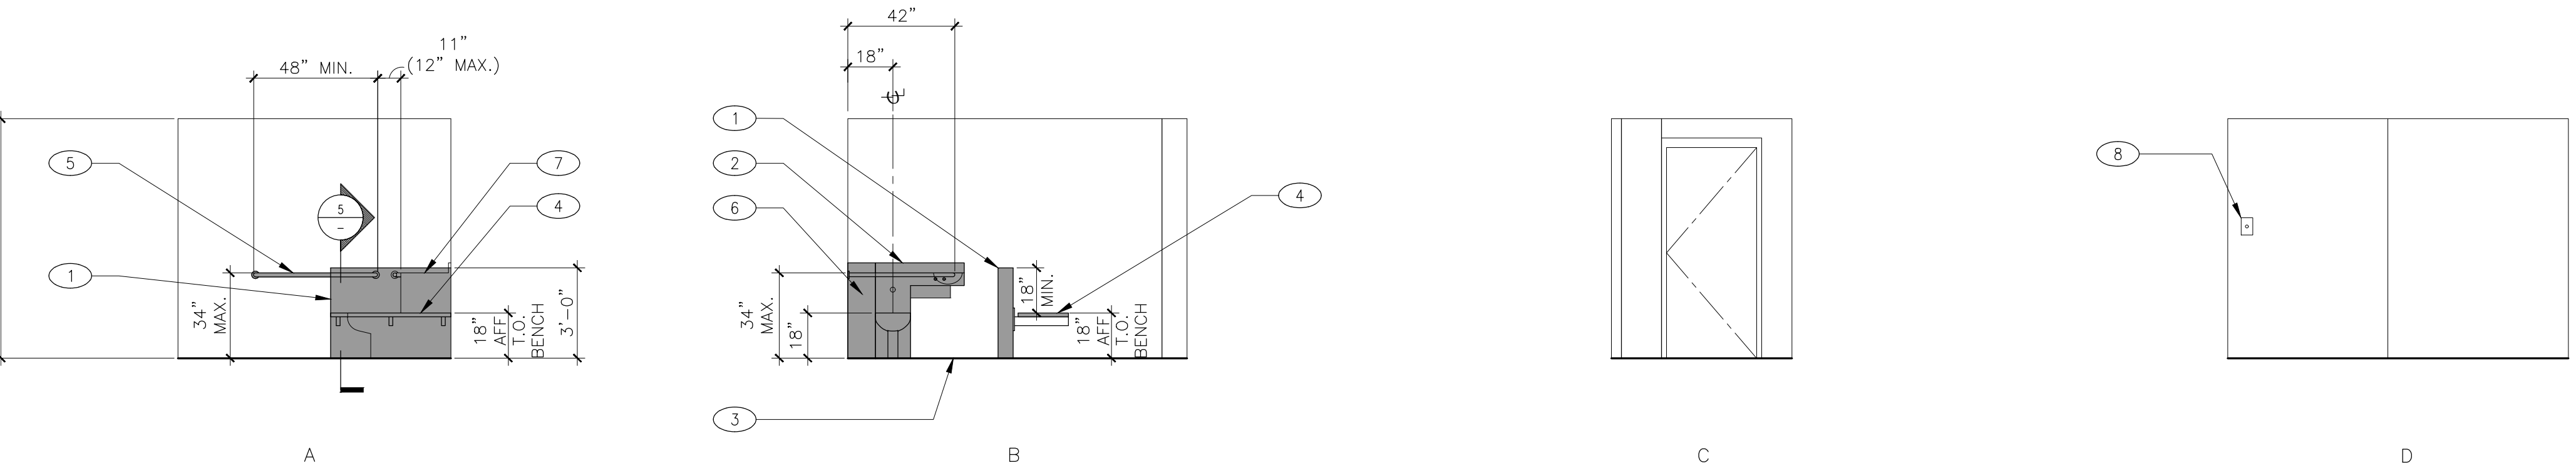


- (FUTURE) SIGNAGE NOTES:
- CHARACTERS, SYMBOLS AND THEIR BACKGROUND SHALL HAVE A NON-GLARE FINISH. CHARACTERS AND SYMBOLS SHALL CONTRAST WITH THEIR BACKGROUND, EITHER LIGHT CHARACTERS ON A DARK BACKGROUND OR DARK CHARACTERS ON A LIGHT BACKGROUND. (CBC 11B-703.5.1)
 - CHARACTERS ON SIGNS SHALL BE SELECTED FROM FONTS WHERE THE WIDTH OF THE UPPER CASE LETTER "O" IS 60% MIN. AND 110% MAX. OF THE HEIGHT OF THE UPPER CASE LETTER "I" AND A STROKE THICKNESS OF THE UPPER CASE LETTER "I" SHALL BE 15% MAX. OF THE HEIGHT OF THE CHARACTER.
 - VISUAL CHARACTERS AND NUMBERS ON SIGNS SHALL BE SIZED ACCORDING TO THE VIEW DISTANCE FROM WHICH THEY ARE TO BE READ, THE MIN. HEIGHT IS MEASURED USING AN UPPERCASE "I". LOWERCASE CHARACTERS ARE PERMITTED. FOR SIGNS SUSPENDED OR PROJECTED ABOVE THE FINISH FLOOR IN COMPLIANCE WITH CBC SECTION 11B-703.5.5, THE MIN. CHARACTER HEIGHT SHALL BE 5/8" (15.9MM). REFER TO ACCOMPANYING DETAILS FOR CHARACTER HEIGHT.
 - CHARACTERS ON SIGNS SHALL BE RAISED 1/32" (0.794 MM) MIN. AND SHALL BE SANS SERIF UPPERCASE CHARACTERS ACCOMPANIED BY GRAD 2 BRAILLE COMPLYING W/ CBC SECTION 11B-703.2 & 11B-703.3.
 - RAISED CHARACTERS SHALL BE A MIN. OF 5/8" (15.9 MM) AND A MAX. OF 2" (51 MM) HIGH (CBC SECTION 11B-1117B.5.5). REFER TO ACCOMPANYING DETAILS FOR CHARACTER HEIGHT.
 - PICTORIAL SYMBOL SIGNS (PICTOGRAMS) SHALL BE ACCOMPANIED BY THE VERBAL DESCRIPTION PLACED DIRECTLY BELOW THE PICTOGRAM. THE OUTSIDE DIMENSION OF THE PICTOGRAM FIELD SHALL BE A MIN. OF 6 INCHES (152 MM) IN HEIGHT (CBC SECTION 11B-703.6.1).

- CONTRACTED CALIFORNIA GRADE 2 BRAILLE. DOT SHALL BE 1/10 INCHES (2.54MM) ON CENTER IN EACH CELL W/ 0.300" 7.62 MM) SPACE BETWEEN CELLS, MEASURED FROM THE SECOND COLUMN OF DOTS IN THE FIRST CELL TO THE FIRST COLUMN OF DOTS IN THE SECOND CELL. DOTS SHALL BE RAISED A MIN. OF 1/40 INCH (0.635 MM) ABOVE THE BACKGROUND (CBC 11B-1117B.5.6).
- WHERE PERMANENT IDENTIFICATION IS PROVIDED FOR ROOMS AND SPACES, SIGN SHALL BE INSTALLED ON THE WALL ADJACENT TO THE LATCH OUTSIDE OF THE DOOR AS INDICATED ON THE ACCOMPANYING DETAIL(S). WHERE THERE IS NO WALL SPACE ON THE LATCH SIDE INCLUDING AT DOUBLE-LEAF DOORS, SIGN SHALL BE PLACED ON THE NEAREST ADJACENT WALL, PREFERABLY ON THE RIGHT, SIGNS SHALL BE LOCATED 48" MIN. A.F.F. OR GROUND SURFACE AS MEASURED FROM THE BASELINE OF THE LOWEST BRAILLE CELLS AND 60" MAX. A.F.F. OR GROUND SURFACE AS MEASURED TO THE BASELINE OF HIGHEST LINE OF RAISED CHARACTERS (11B-703.4.1). SIGNS CONTAINING TACTILE CHARACTERS SHALL BE LOCATED SO THAT A CLEAR FLOOR SPACE OF 18" MIN. x 18" MIN. CENTERED ON THE TACTILE CHARACTERS IS PROVIDED BEYOND THE ARC OF ANY DOOR SWING BETWEEN THE CLOSED POSITION AND 45° OPEN POSITION.
- THE INTERNATIONAL SYMBOL OF ACCESSIBILITY (ISA) SHALL BE THE STANDARD USED TO IDENTIFY FACILITIES THAT ARE ACCESSIBLE TO AND USABLE BY PHYSICALLY DISABLED PERSON. THE SYMBOL SHALL CONSIST OF A WHITE FIGURE ON A BLUE BACKGROUND. THE BLUE SHALL BE EQUAL TO COLOR No. 15090 IN FEDERAL STANDARD 595C.

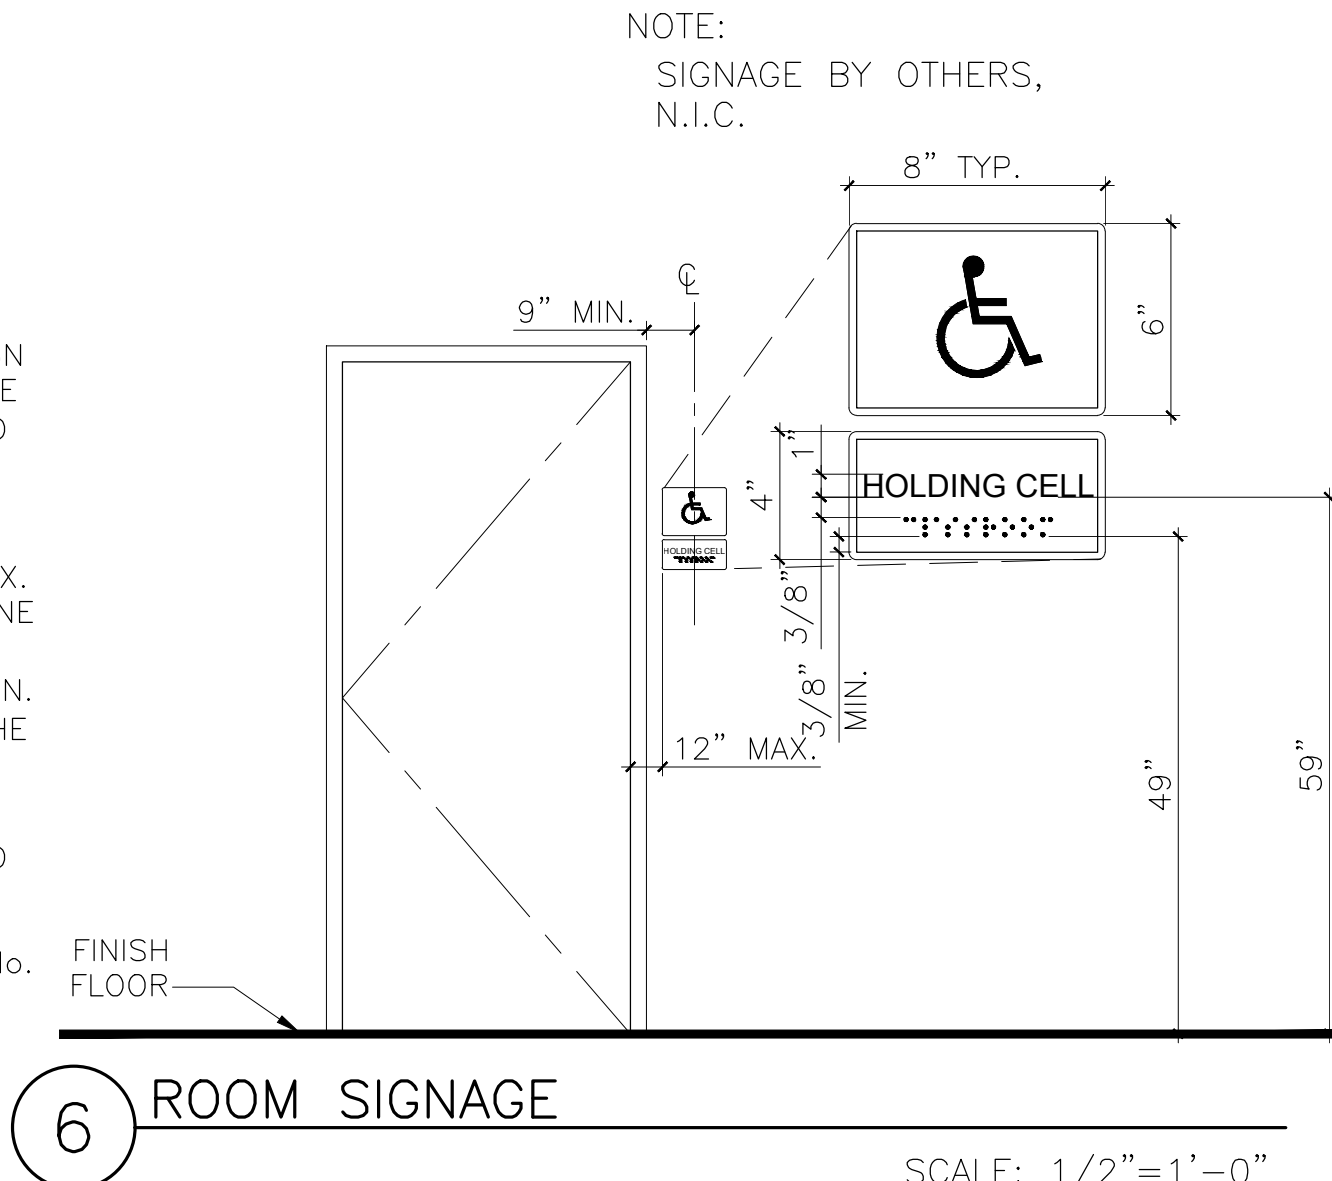

6 ROOM SIGNAGE

SCALE: 1/2"=1'-0"

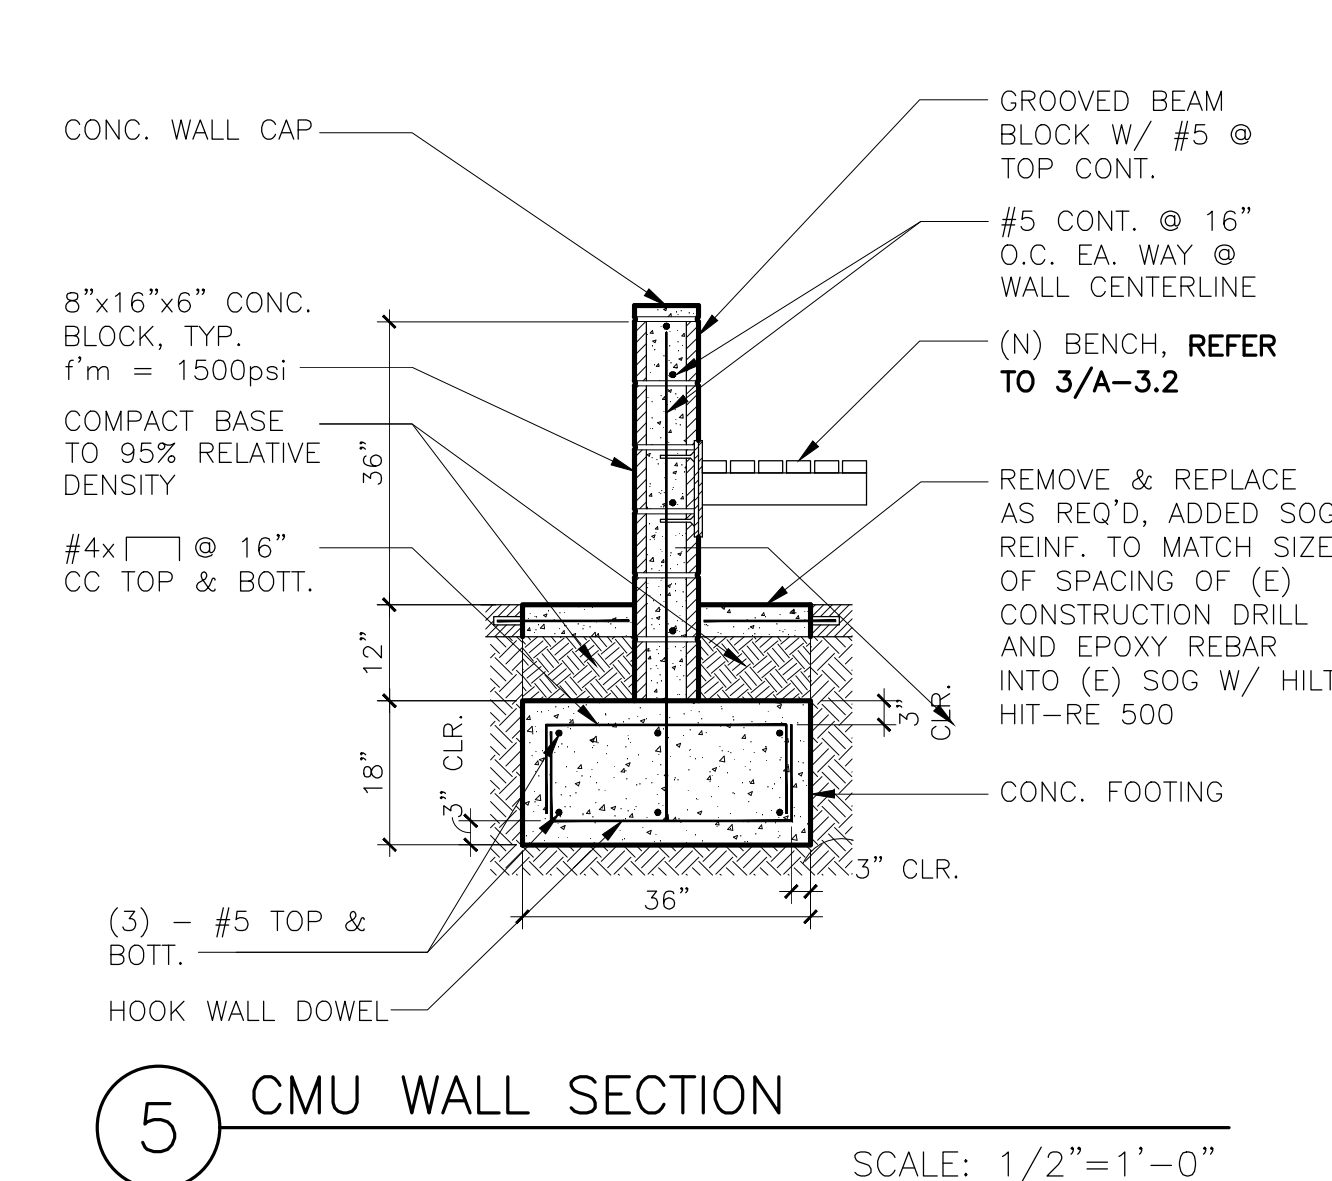

5 CMU WALL SECTION

SCALE: 1/2"=1'-0"

NEW KEYNOTES

- (N) 3FT. HIGH 8"x16"x6" CMU PONY WALL, PAINT TO MATCH (E), PATCH & REPAIR AREA OF CONC. FLOOR REMOVAL, INCLUDING CONC. FLOOR SEALANT TO MATCH (E), REFER TO 5/-
- (N) ADA TOILET/SINK COMBI FIXTURE W/ GRAB BARS W/ CLOSURE PLATES, REFER TO PLUMBING FIXTURE SCHEDULE ON P-0.2, REFER TO 1/A-3.2 FOR GRAB BAR ANCHORAGE AND CLOSURE PLATES
- PATCH & REPAIR CONC. @ CMU PONY WALL REMOVAL
- (N) 48"x21" ADA HEIGHT BENCH CAPABLE OF WITHSTANDING VERTICAL AND HORIZONTAL FORCES OF 250 LBS. MIN., REFER TO 3/A-3.2
- (N) GRAB BAR BEYOND PONY WALL
- COMBI UNIT INFILL PANEL, FRONT AND TOP, BY MFR.
- (N) COMBI FIXTURE BEYOND PONY WALL
- (E) INTERCOM TO REMAIN
- (FUTURE) ROOM I.D. SIGN BY OTHERS, N.I.C., REFER TO 6/-

LEGEND

	DEMOLITION
	(E) CMU WALL
	(E) CONC. WALL
	NEW WORK
	NEW WALL OR NEW FIXTURE

Sally Swanson Architects, Inc.
SSA
 500 Sansome St, Suite 410
 San Francisco, CA 94111
 Tel: 415.445.3045
 Fax: 415.445.3055
 ssa@swanarch.com

Architecture
 Planning
 Accessible Design

ARCHITECT STAMP

NOT APPROVED FOR CONSTRUCTION

DATE _____

PROJECT: MARIN COUNTY CORRECTIONAL FACILITY BOOKING AREA BARRIER REMOVAL PROJECT

DRAWING TITLE: **HOLDING CELL**


SCALE: AS NOTED

JOB NUMBER: 20013.00


DRAWING NUMBER: **A-2.1**

CHECKED BY: K.W. & S.S.

SHEET NO. _____ OF _____

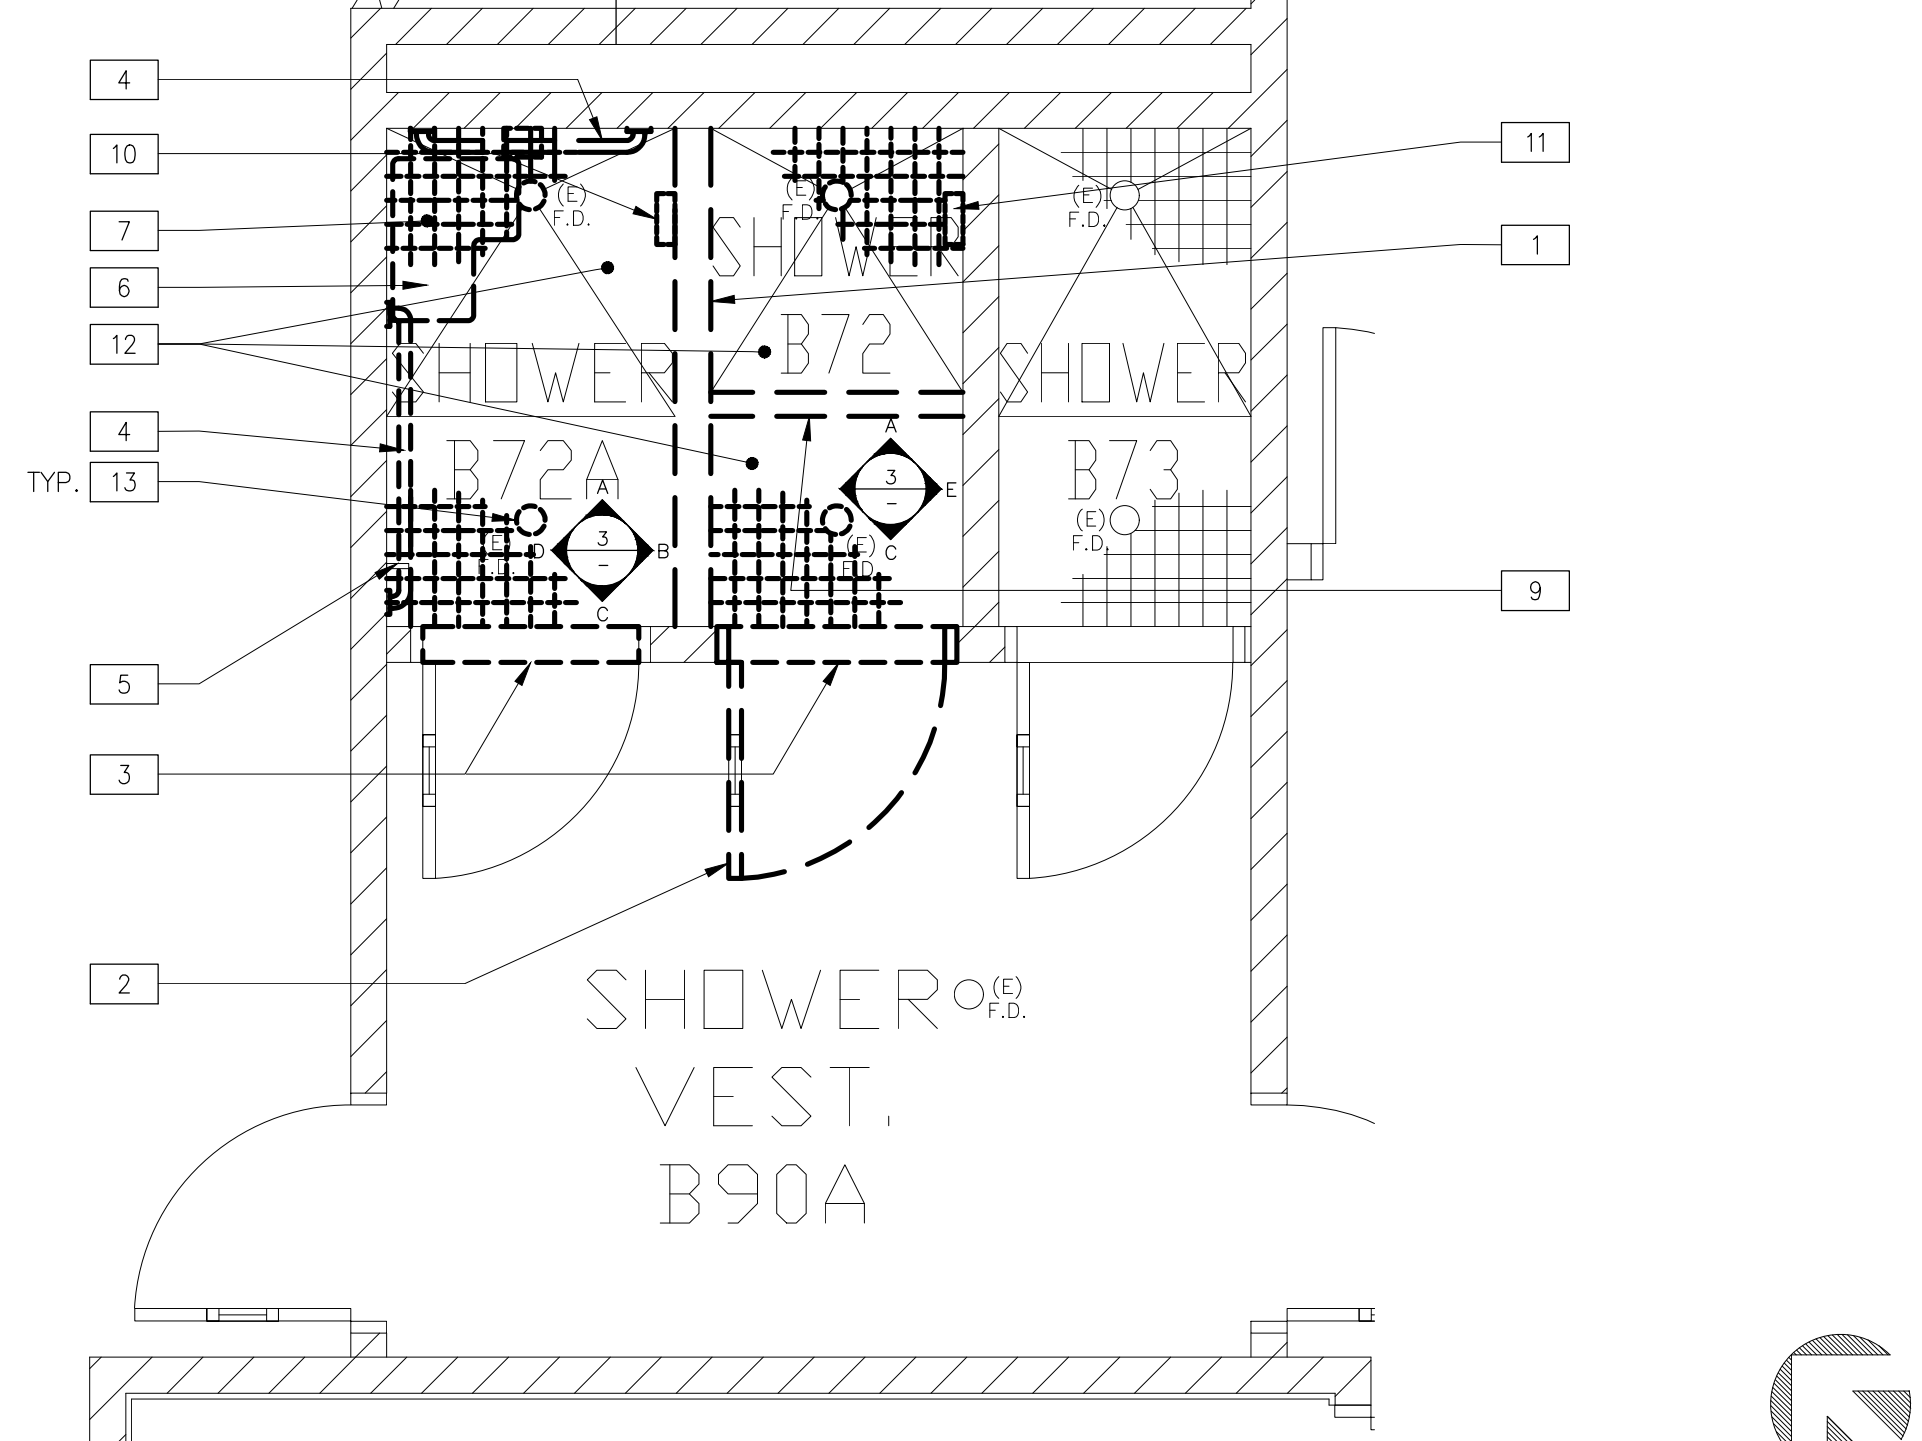

1 DEMO SHOWER FLOOR PLAN SCALE: 3/8"=1'-0"

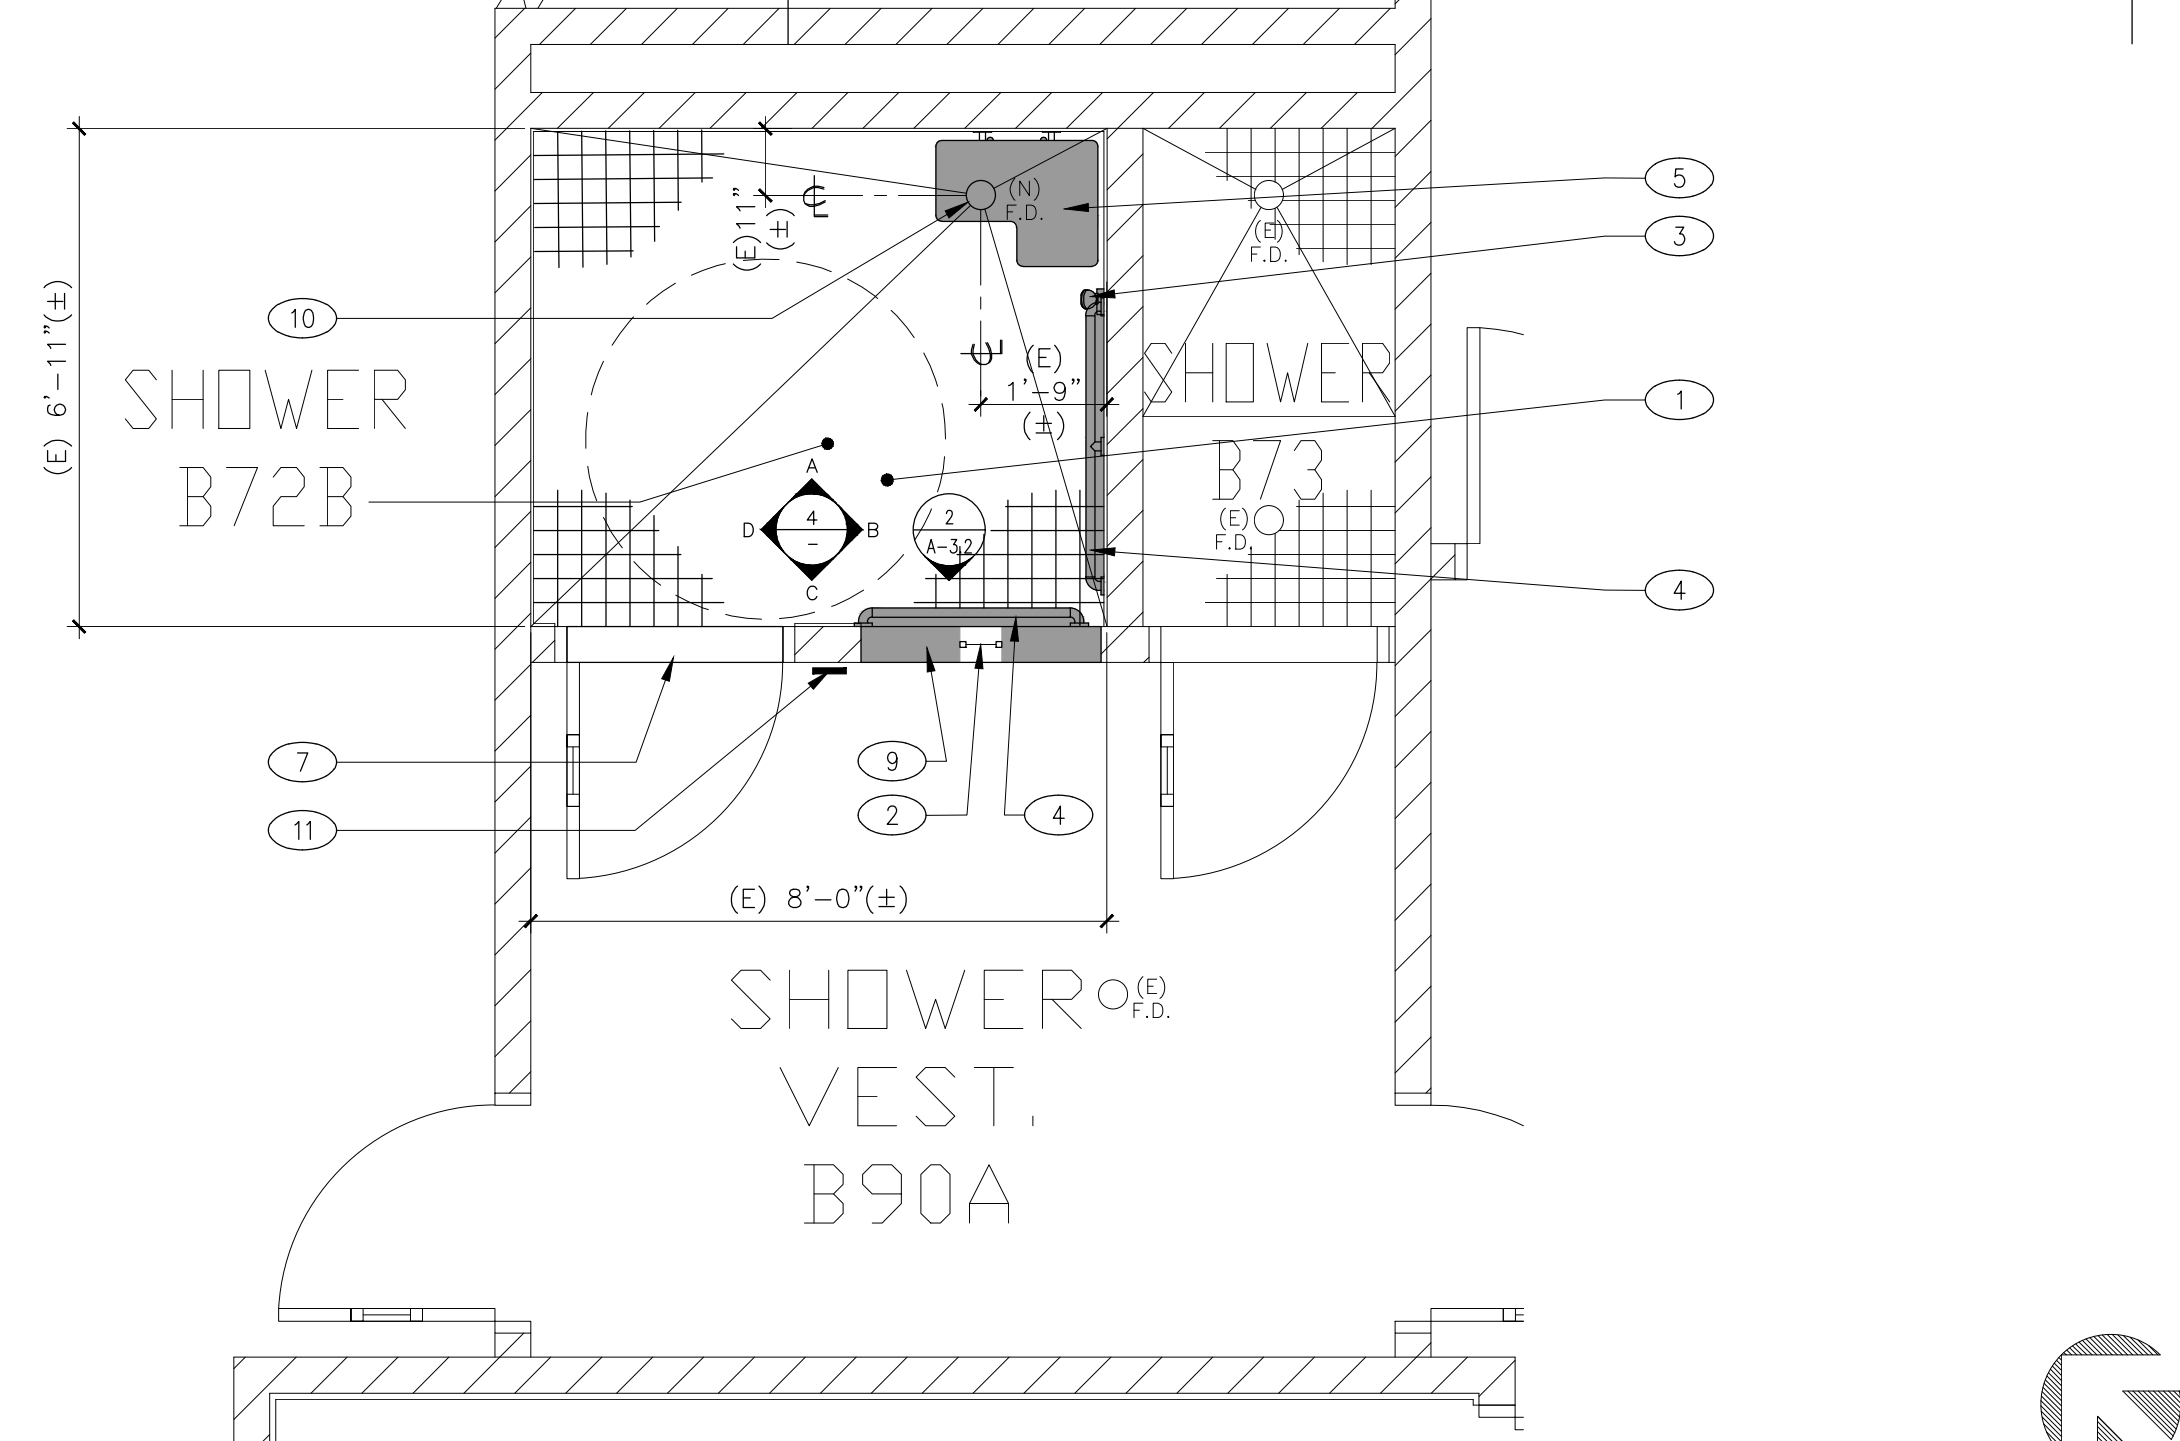

2 NEW SHOWER FLOOR PLAN SCALE: 3/8"=1'-0"

- PLAN & ELEVATION NOTES**
- COORDINATE DEMOLITION WITH NEW CONSTRUCTION DRAWINGS FOR DEMOLITION, SALVAGE, PROTECTION AND RESTORATION OF (E) ITEMS. CONTRACTOR SHALL VERIFY (E) CONDITION PRIOR TO DEMOLITION COMMENCEMENT. PROCEED WITH CAUTION TO AVOID POSSIBLE (E) UNDERGROUND UTILITY LINES, CONDUIT, PIPING, ETC.
 - IF ANY DEMO OF (E) CONC. IS REQ'D, SCAN FOR UTILITIES AND REBAR PRIOR TO WORK.
 - PATCH AND REPAIR DEMO WALL FINISH TO MATCH (E).
 - PATCH AND REPAIR DEMO CEILING FINISH TO MATCH (E).
 - PATCH AND REPAIR DEMO FLOOR FINISH TO MATCH (E).
 - EXAMINE ALL FINISH SURFACES AFTER COMPLETION OF WORK AND PROCEED WITH "TOUCH-UP" AS REQUIRED.

ISSUES/REVISIONS :

No.	DESCRIPTION	DATE
1	SCHEMATIC DESIGN	06-15-2020
2	60% DESIGN DOCUMENTS	07-10-2020
3	95% DESIGN DOCUMENTS	08-07-2020
4	100% DESIGN DOCUMENTS	09-04-2020
5	PLAN CHECK SUBMISSION	09-28-2020



COUNTY OF MARIN, DEPARTMENT OF PUBLIC WORKS
PROJECT ACCEPTED BY:

- DEMO KEYNOTES**
- REMOVE (E) CMU WALL
 - REMOVE (E) DOOR & FRAME
 - REMOVE (E) THRESHOLD
 - REMOVE (E) GRAB BAR
 - (E) CLOTHING HOOK TO REMAIN, PROTECT IN PLACE
 - REMOVE (E) FOLDING SHOWER SEAT
 - REMOVE (E) FLOOR TILE & BASE TILE
 - REMOVE (E) WALL TILE
 - REMOVE (E) 4" CONC. CURB
 - REMOVE (E) SHOWER CONTROL CONSOLE
 - REMOVE (E) SHOWER CONTROL CONSOLE FOR RE-USE IF POSSIBLE, IF NOT SALVAGEABLE, DISCARD & REMOVE FROM SITE
 - REMOVE (E) CONC. SLAB AS REQ'D FOR INSTALLATION OF (N) CERAMIC FLOOR TILE W/ 1.9% MAX. SLOPE TO (N) DRAIN
 - REMOVE (E) FLOOR DRAIN

- NEW KEYNOTES**
- (N) CERAMIC FLOOR TILE, COLOR SIM. TO (E), (E) AND (N) FLOORING SHALL SLOPE TO (N) DRAIN
 - (N) WINDOW W/ ALUM. FRAME W/ 1/2" CLEAR POLYCARBONATE SECURITY GLAZING @ (N) WALL INFILL
 - (N) SHOWER CONTROL CONSOLE OR (E) REMOUNTED @ ADA HEIGHT
 - (N) ADA GRAB BAR W/ CLOSURE PLATE, REFER TO 1/A-3.2
 - (N) FOLDING ADA SHOWER SEAT
 - (N) CERAMIC WALL TILE AND BASE TILE, COLOR SIM. TO (E), REFER TO 4/A-3.1
 - (N) ADA THRESHOLD, REFER TO 2/A-3.1
 - PATCH & REPAIR CEILING TO MATCH (E) @ WALL REMOVAL, PAINT ENTIRE CEILING
 - (N) CMU WALL INFILL @ REMOVED DOOR W/ (N) CERAMIC WALL TILE @ SHOWER SIDE, PAINT ENTIRE WALL TO MATCH (E) @ VESTIBULE SIDE, REFER TO 2/A-3.2
 - (N) FLOOR DRAIN W/ TRAP PRIMER, PROVIDE (N) PIPE/DRAIN EXTENSION AS REQ'D TO RAISE DRAIN TO ACHIEVE MAX. 1.9% SLOPE FOR ADA COMPLIANCE, REFER TO 1/A-3.1, 3/P-2.1
 - (FUTURE) ROOM I.D. SIGN BY OTHERS, N.I.C., REFER TO 6/-

Sally Swanson Architects, Inc.

SSA

500 Sansome St, Suite 410
San Francisco, CA 94111
Tel: 415.445.3045
Fax: 415.445.3055
ssa@swanarch.com

Architecture
Planning
Accessible Design

- NOT APPROVED FOR CONSTRUCTION**
- ARCHITECT STAMP
- DATE _____
- PROJECT: MARIN COUNTY CORRECTIONAL FACILITY BOOKING AREA BARRIER REMOVAL PROJECT
- 13 PETER BEHR DRIVE SAN RAFAEL, CA 94903

ARCHITECT STAMP

NOT APPROVED FOR CONSTRUCTION

DATE _____

DRAWING TITLE

SHOWER


SCALE: AS NOTED

JOB NUMBER: 20013.00


DRAWING NUMBER: A-2.2

CHECKED BY: K.W. & S.S.

SHEET NO. _____ OF _____

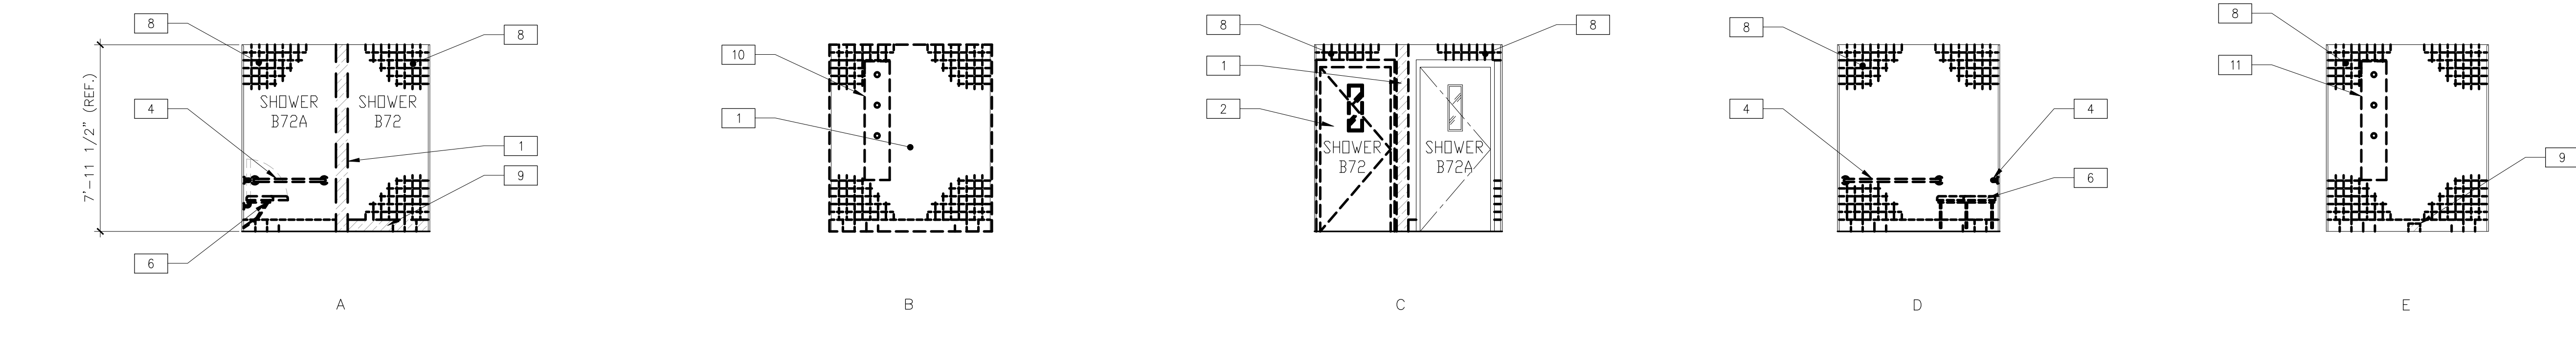

3 DEMO SHOWERS B72 & B72A ELEVATIONS SCALE: 1/4"=1'-0"

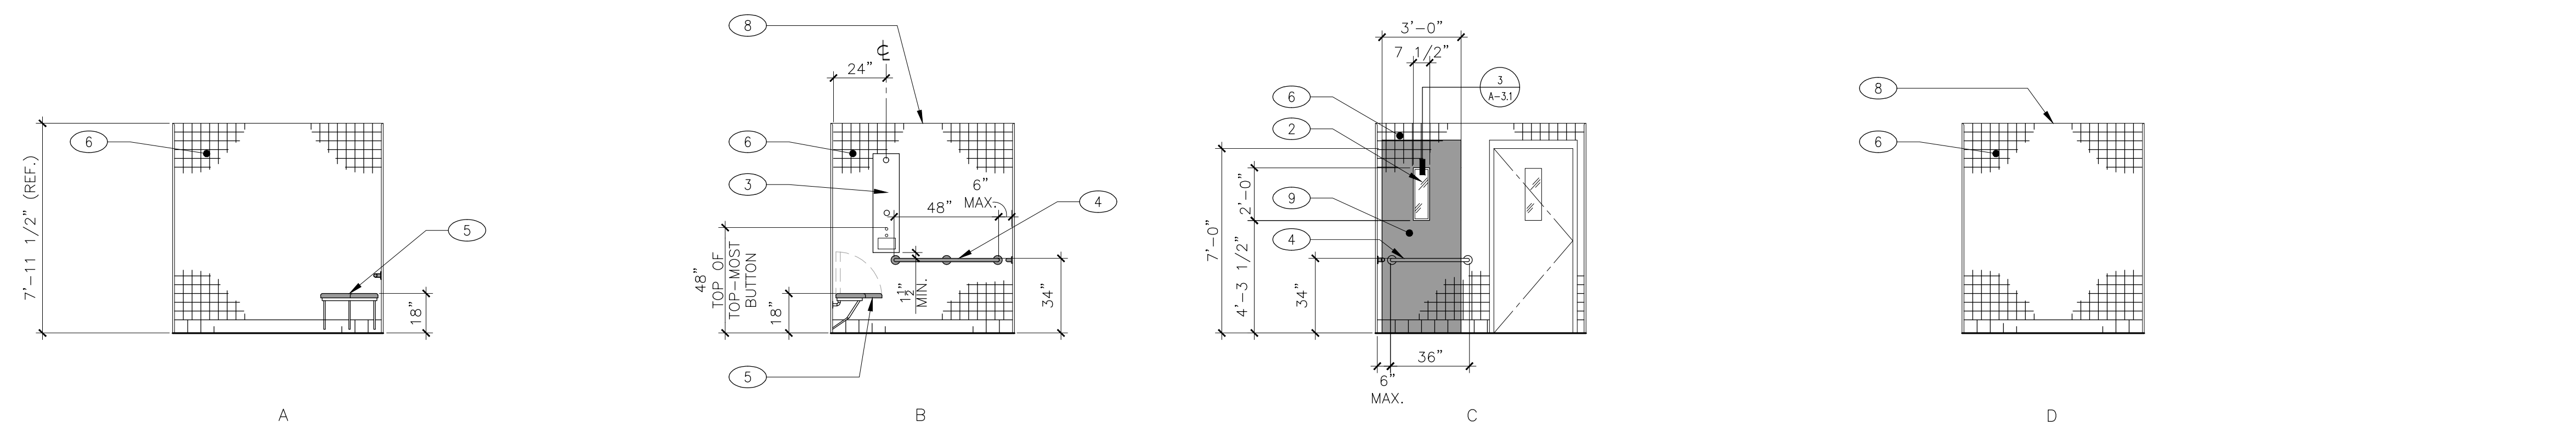

4 NEW SHOWER ELEVATIONS SCALE: 1/4"=1'-0"


(FUTURE) SIGNAGE NOTES:

- CHARACTERS, SYMBOLS AND THEIR BACKGROUND SHALL HAVE A NON-GLARE FINISH. CHARACTERS AND SYMBOLS SHALL CONTRAST WITH THEIR BACKGROUND, EITHER LIGHT CHARACTERS ON A DARK BACKGROUND OR DARK CHARACTERS ON A LIGHT BACKGROUND. (CBC 11B-703.5.1)
- CHARACTERS ON SIGNS SHALL BE SELECTED FROM FONTS WHERE THE WIDTH OF THE UPPER CASE LETTER "O" IS 60% MIN. AND 110% MAX. OF THE HEIGHT OF THE UPPER CASE LETTER "I" AND A STROKE THICKNESS OF THE UPPER CASE LETTER "I" SHALL BE 15% MAX. OF THE HEIGHT OF THE CHARACTER.
- VISUAL CHARACTERS AND NUMBERS ON SIGNS SHALL BE SIZED ACCORDING TO THE VIEW DISTANCE FROM WHICH THEY ARE TO BE READ, THE MIN. HEIGHT IS MEASURED USING AN UPPER CASE "I". LOWER CASE CHARACTERS ARE PERMITTED, FOR SIGNS SUSPENDED OR PROJECTED ABOVE THE FINISH FLOOR IN COMPLIANCE WITH CBC SECTION 11B-703.5.5, THE MIN. CHARACTER HEIGHT SHALL BE 5/8" (15.9MM). REFER TO ACCOMPANYING DETAILS FOR CHARACTER HEIGHT.
- CHARACTERS ON SIGNS SHALL BE RAISED 1/32" (0.794 MM) MIN. AND SHALL BE SANS SERIF UPPER CASE CHARACTERS ACCOMPANIED BY GRAD 2 BRAILLE COMPLYING W/ CBC SECTION 11B-703.2 & 11B-703.3.
- RAISED CHARACTERS SHALL BE A MIN. OF 5/8" (15.9 MM) AND A MAX. OF 2" (51 MM) HIGH (CBC SECTION 11B-1117B.5.5). REFER TO ACCOMPANYING DETAILS FOR CHARACTER HEIGHT.
- PICTORIAL SYMBOL SIGNS (PICTOGRAMS) SHALL BE ACCOMPANIED BY THE VERBAL DESCRIPTION PLACED DIRECTLY BELOW THE PICTOGRAM. THE OUTSIDE DIMENSION OF THE PICTOGRAM FIELD SHALL BE A MIN. OF 6 INCHES (152 MM) IN HEIGHT (CBC SECTION 11B-703.6.1).
- CONTRACTED CALIFORNIA GRADE 2 BRAILLE. DOT SHALL BE 1/10 INCHES (2.54MM) ON CENTER IN EACH CELL W/ 0.300" 7.62 MM) SPACE BETWEEN CELLS, MEASURED FROM THE SECOND COLUMN OF DOTS IN THE FIRST CELL TO THE FIRST COLUMN OF DOTS IN THE SECOND CELL. DOTS SHALL BE RAISED A MIN. OF 1/40 INCH (0.635 MM) ABOVE THE BACKGROUND (CBC 11B-1117B.5.6).
- WHERE PERMANENT IDENTIFICATION IS PROVIDED FOR ROOMS AND SPACES, SIGN SHALL BE INSTALLED ON THE WALL ADJACENT TO THE LATCH OUTSIDE OF THE DOOR AS INDICATED ON THE ACCOMPANYING DETAILS. WHERE THERE IS NO WALL SPACE ON THE LATCH SIDE INCLUDING AT DOUBLE-LEAF DOORS, SIGN SHALL BE PLACED ON THE NEAREST ADJACENT WALL, PREFERABLY ON THE RIGHT, SIGNS SHALL BE LOCATED 48" MIN. A.F.F. OR GROUND SURFACE AS MEASURED FROM THE BASELINE OF THE LOWEST BRAILLE CELLS AND 60" MAX. A.F.F. OR GROUND SURFACE AS MEASURED TO THE BASELINE OF HIGHEST LINE OF RAISED CHARACTERS (11B-703.4.1). SIGNS CONTAINING TACTILE CHARACTERS SHALL BE LOCATED SO THAT A CLEAR FLOOR SPACE OF 18" MIN. x 18" MIN. CENTERED ON THE TACTILE CHARACTERS IS PROVIDED BEYOND THE ARC OF ANY DOOR SWING BETWEEN THE CLOSED POSITION AND 45° OPEN POSITION.
- THE INTERNATIONAL SYMBOL OF ACCESSIBILITY (ISA) SHALL BE THE STANDARD USED TO IDENTIFY FACILITIES THAT ARE ACCESSIBLE TO AND AND USABLE BY PHYSICALLY DISABLED PERSON. THE SYMBOL SHALL CONSIST OF A WHITE FIGURE ON A BLUE BACKGROUND. THE BLUE SHALL BE EQUAL TO COLOR NO. 15090 IN FEDERAL STANDARD 595C.

NOTE: SIGNAGE BY OTHERS, N.I.C.


5 ROOM SIGNAGE MOUNTING LOCATION SCALE: 1/2"=1'-0"

- LEGEND**
- DEMOLITION
 - /// (E) CMU WALL
 - NEW WORK
 - NEW WALL OR NEW FIXTURE

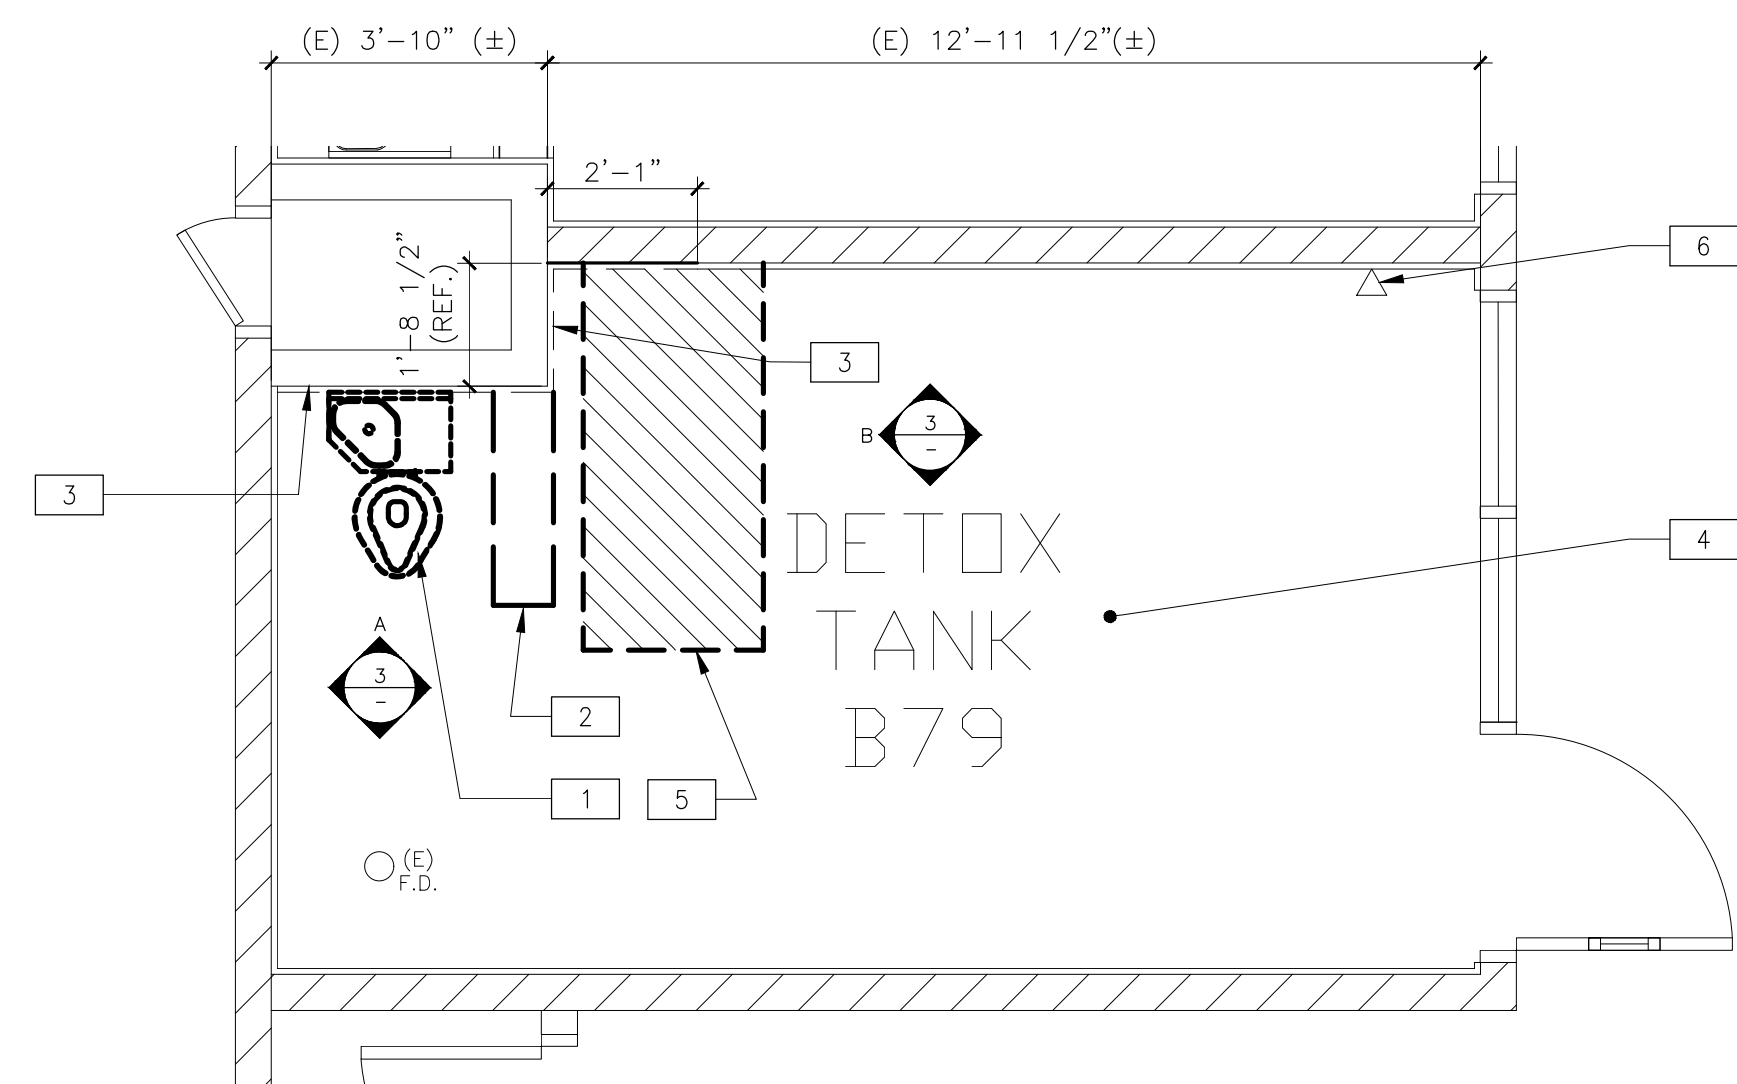



1 DEMO DETOX TANK FLOOR PLAN

SCALE: 3/8"=1'-0"

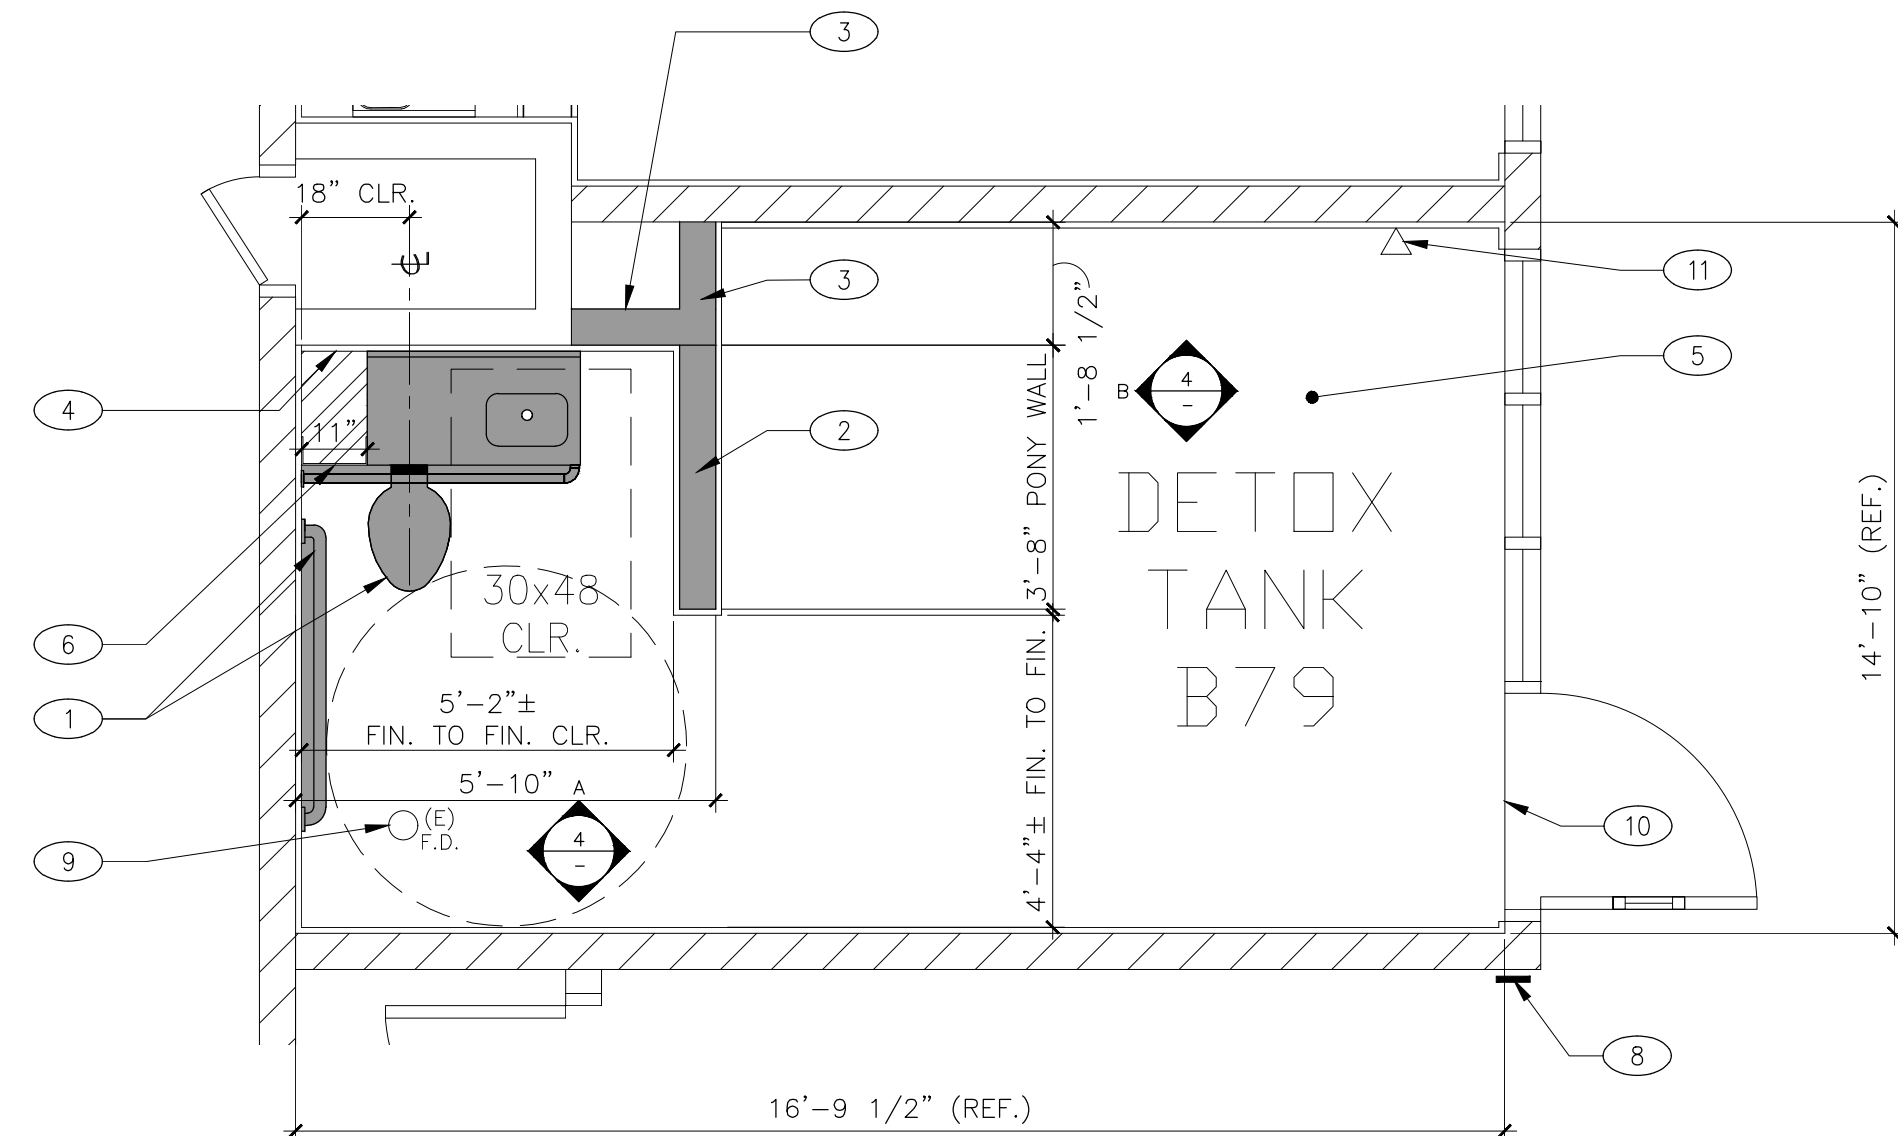



2 NEW DETOX TANK FLOOR PLAN

SCALE: 3/8"=1'-0"

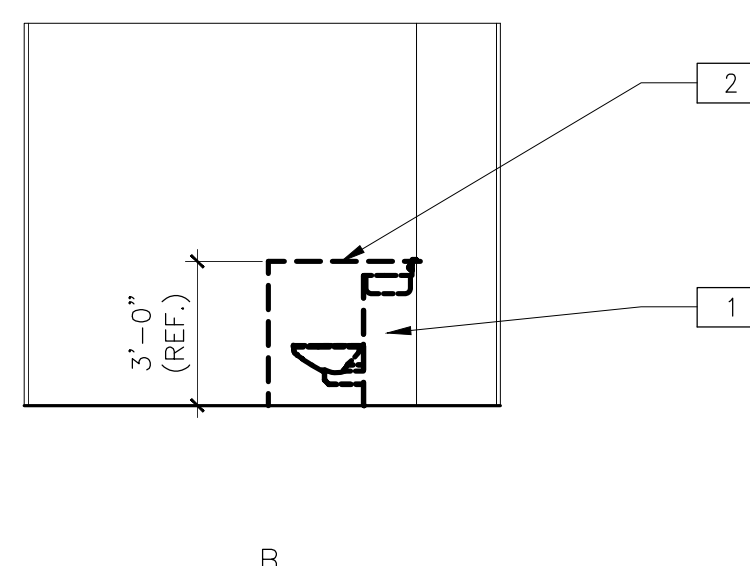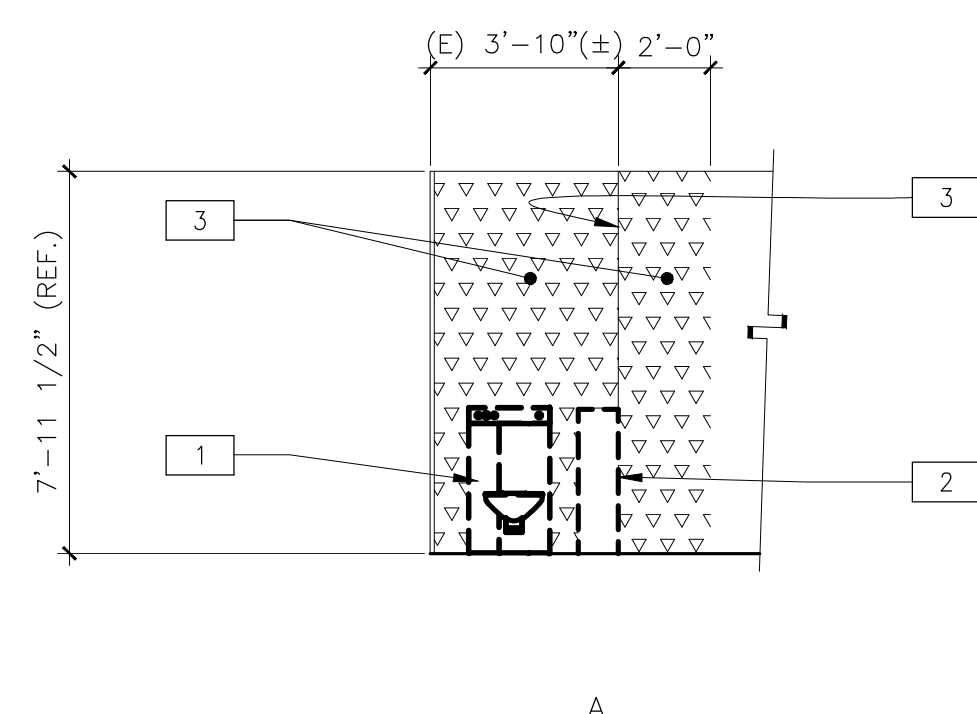

3 DEMO DETOX TANK ELEVATIONS

SCALE: 1/4"=1'-0"

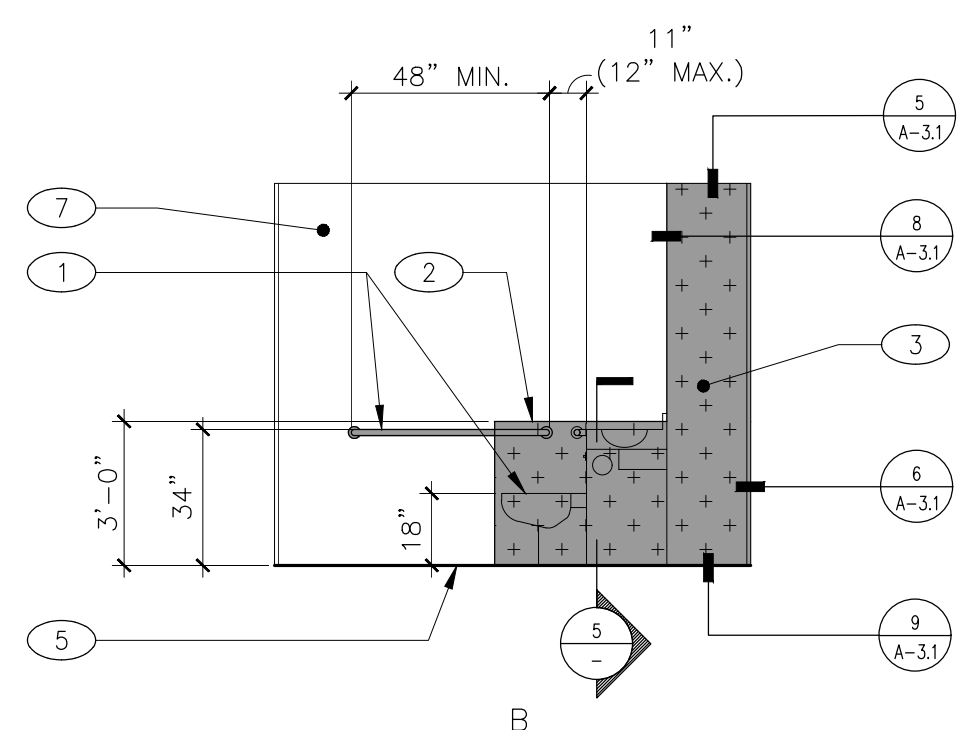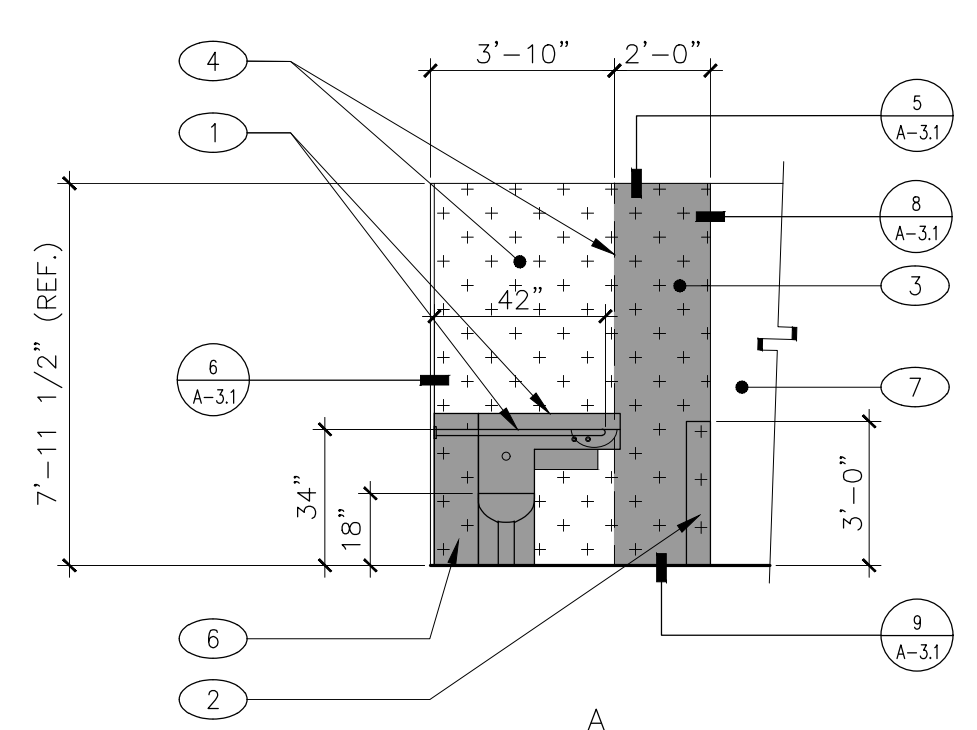

4 NEW DETOX TANK ELEVATIONS


SCALE: 1/4"=1'-0"

(FUTURE) SIGNAGE NOTES:

- CHARACTERS, SYMBOLS AND THEIR BACKGROUND SHALL HAVE A NON-GLARE FINISH. CHARACTERS AND SYMBOLS SHALL CONTRAST WITH THEIR BACKGROUND, EITHER LIGHT CHARACTERS ON A DARK BACKGROUND OR DARK CHARACTERS ON A LIGHT BACKGROUND. (CBC 11B-703.5.1)
- CHARACTERS ON SIGNS SHALL BE SELECTED FROM FONTS WHERE THE WIDTH OF THE UPPER CASE LETTER "O" IS 60% MIN. AND 110% MAX. OF THE HEIGHT OF THE UPPER CASE LETTER "I" AND A STROKE THICKNESS OF THE UPPER CASE LETTER "I" SHALL BE 15% MAX. OF THE HEIGHT OF THE CHARACTER.
- VISUAL CHARACTERS AND NUMBERS ON SIGNS SHALL BE SIZED ACCORDING TO THE VIEW DISTANCE FROM WHICH THEY ARE TO BE READ, THE MIN. HEIGHT IS MEASURED USING AN UPPERCASE "I". LOWERCASE CHARACTERS ARE PERMITTED. FOR SIGNS SUSPENDED OR PROJECTED ABOVE THE FINISH FLOOR IN COMPLIANCE WITH CBC SECTION 11B-703.5.5, THE MIN. CHARACTER HEIGHT SHALL BE 5/8" (15.9MM). REFER TO ACCOMPANYING DETAILS FOR CHARACTER HEIGHT.
- CHARACTERS ON SIGNS SHALL BE RAISED 1/32" (0.794 MM) MIN. AND SHALL BE SANS SERIF UPPERCASE CHARACTERS ACCOMPANIED BY GRAD 2 BRAILLE COMPLYING W/ CBC SECTION 11B-703.2 & 11B-703.3.
- RAISED CHARACTERS SHALL BE A MIN. OF 5/8" (15.9 MM) AND A MAX. OF 2" (51 MM) HIGH (CBC SECTION 11B-1117B.5.5). REFER TO ACCOMPANYING DETAILS FOR CHARACTER HEIGHT.
- PICTORIAL SYMBOL SIGNS (PICTOGRAMS) SHALL BE ACCOMPANIED BY THE VERBAL DESCRIPTION PLACED DIRECTLY BELOW THE PICTOGRAM. THE OUTSIDE DIMENSION OF THE PICTOGRAM FIELD SHALL BE A MIN. OF 6 INCHES (152 MM) IN HEIGHT (CBC SECTION 11B-703.6.1).


- CONTRACTED CALIFORNIA GRADE 2 BRAILLE. DOT SHALL BE 1/10 INCHES (2.54MM) ON CENTER IN EACH CELL W/ 0.300" 7.62 MM) SPACE BETWEEN CELLS, MEASURED FROM THE SECOND COLUMN OF DOTS IN THE FIRST CELL TO THE FIRST COLUMN OF DOTS IN THE SECOND CELL. DOTS SHALL BE RAISED A MIN. OF 1/40 INCH (0.635 MM) ABOVE THE BACKGROUND (CBC 11B-1117B.5.6).
- WHERE PERMANENT IDENTIFICATION IS PROVIDED FOR ROOMS AND SPACES, SIGN SHALL BE INSTALLED ON THE WALL ADJACENT TO THE LATCH OUTSIDE OF THE DOOR AS INDICATED ON THE ACCOMPANYING DETAIL(S). WHERE THERE IS NO WALL SPACE ON THE LATCH SIDE INCLUDING AT DOUBLE-LEAF DOORS, SIGN SHALL BE PLACED ON THE NEAREST ADJACENT WALL, PREFERABLY ON THE RIGHT, SIGNS SHALL BE LOCATED 48" MIN. A.F.F. OR GROUND SURFACE AS MEASURED FROM THE BASELINE OF THE LOWEST BRAILLE CELLS AND 60" MAX. A.F.F. OR GROUND SURFACE AS MEASURED TO THE BASELINE OF HIGHEST LINE OF RAISED CHARACTERS (11B-703.4.1). SIGNS CONTAINING TACTILE CHARACTERS SHALL BE LOCATED SO THAT A CLEAR FLOOR SPACE OF 18" MIN. x 18" MIN. CENTERED ON THE TACTILE CHARACTERS IS PROVIDED BEYOND THE ARC OF ANY DOOR SWING BETWEEN THE CLOSED POSITION AND 45° OPEN POSITION.
- THE INTERNATIONAL SYMBOL OF ACCESSIBILITY (ISA) SHALL BE THE STANDARD USED TO IDENTIFY FACILITIES THAT ARE ACCESSIBLE TO AND USABLE BY PHYSICALLY DISABLED PERSON. THE SYMBOL SHALL CONSIST OF A WHITE FIGURE ON A BLUE BACKGROUND. THE BLUE SHALL BE EQUAL TO COLOR NO. 15090 IN FEDERAL STANDARD 595C.

NOTE:
SIGNAGE BY OTHERS,
N.I.C.

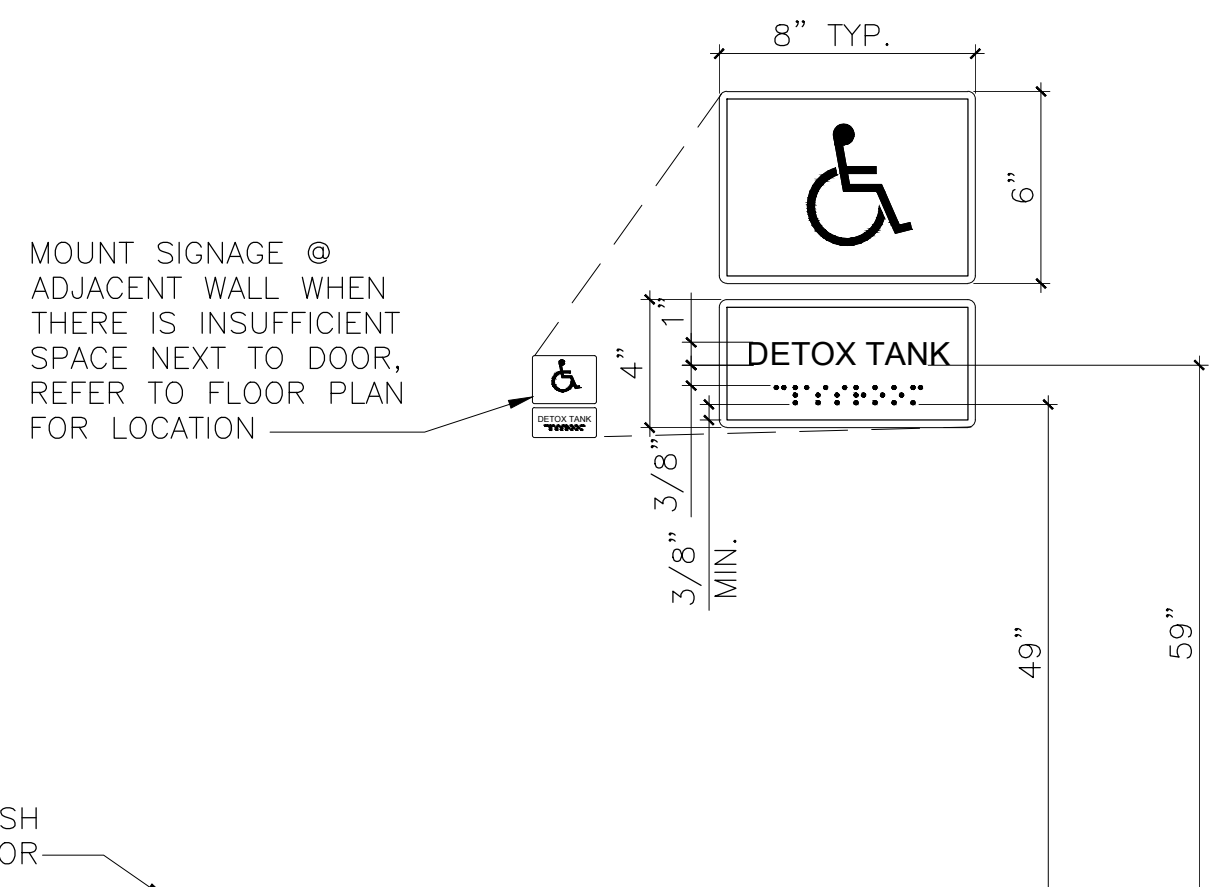

6 ROOM SIGNAGE MOUNTING LOCATION

SCALE: 1/2"=1'-0"

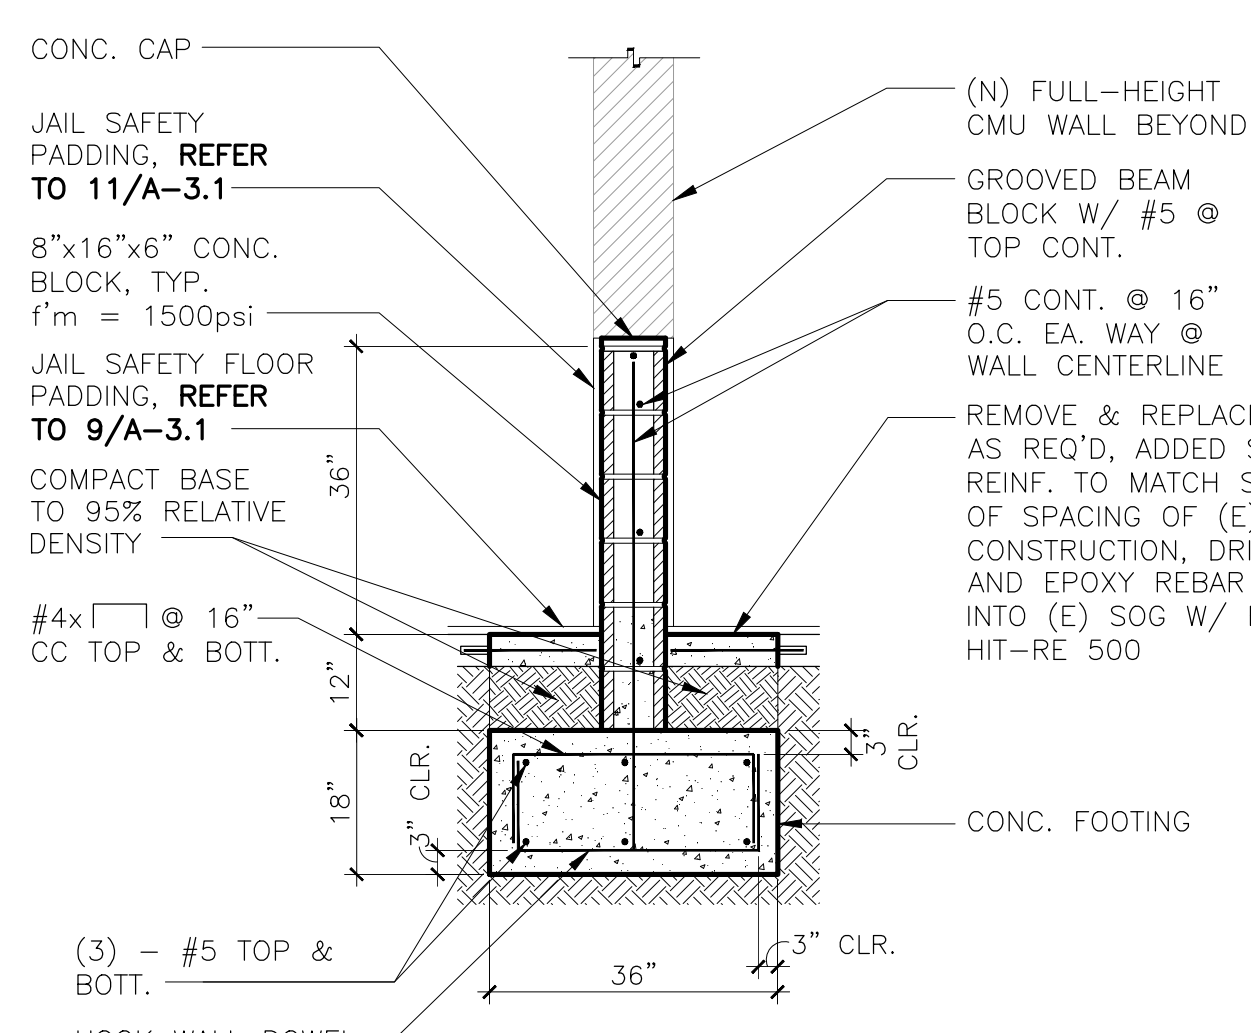

5 CMU WALL SECTION

SCALE: 1/2"=1'-0"

PLAN & ELEVATION NOTES

- COORDINATE DEMOLITION WITH NEW CONSTRUCTION DRAWINGS FOR DEMOLITION, SALVAGE, PROTECTION AND RESTORATION OF (E) ITEMS. CONTRACTOR SHALL VERIFY (E) CONDITION PRIOR TO DEMOLITION COMMENCEMENT. PROCEED WITH CAUTION TO AVOID POSSIBLE (E) UNDERGROUND UTILITY LINES, CONDUIT, PIPING, ETC.
- IF ANY DEMO OF (E) CONC. IS REQ'D, SCAN FOR UTILITIES AND REBAR PRIOR TO WORK.
- PATCH AND REPAIR DEMO WALL FINISH TO MATCH (E).
- PATCH AND REPAIR DEMO CEILING FINISH TO MATCH (E).
- PATCH AND REPAIR DEMO FLOOR FINISH TO MATCH (E).
- EXAMINE ALL FINISH SURFACES AFTER COMPLETION OF WORK AND PROCEED WITH "TOUCH-UP" AS REQUIRED.

ISSUES/REVISIONS :

No.	DESCRIPTION	DATE
1	SCHEMATIC DESIGN	06-15-2020
2	60% DESIGN DOCUMENTS	07-10-2020
3	95% DESIGN DOCUMENTS	08-07-2020
4	100% DESIGN DOCUMENTS	09-04-2020
5	PLAN CHECK SUBMISSION	09-28-2020



COUNTY OF MARIN, DEPARTMENT OF PUBLIC WORKS
PROJECT ACCEPTED BY:

DEMO KEYNOTES

- REMOVE (E) TOILET/SINK COMBI FIXTURE, PREPARE TO RECEIVE (N) COMBI FIXTURE
- REMOVE (E) FRAMED PONY WALL
- REMOVE (E) SAFETY PADDING
- REMOVE (E) SAFETY PADDING FLOOR FINISH, ENTIRE ROOM
- REMOVE AREA OF (E) SLAB AS REQ'D TO INSTALL (N) CMU PONY WALL & FOOTING
- (E) INTERCOM TO REMAIN

NEW KEYNOTES

- (N) ADA TOILET/SINK COMBI FIXTURE W/ GRAB BARS W/ CLOSURE PLATES. REFER TO PLUMBING FIXTURE SCHEDULE ON P-0.2, REFER TO 1/A-3.2 FOR GRAB BAR ANCHORAGE AND CLOSURE PLATES
- (N) 3FT. HIGH 8"x16"x16" CMU PONY WALL W/ (N) 1" THK. JAIL SAFETY PADDING TO MATCH (E), ALL SIDES AND TOP, PATCH & REPAIR CONC. AT AREA OF FLOOR REMOVAL. REFER TO 5/- AND 11/A-3.1
- (N) FULL HEIGHT 8"x16"x16" CMU WALL W/ (N) 1" THK. JAIL SAFETY PADDING TO MATCH (E), PATCH & REPAIR CONC. AT AREA OF FLOOR REMOVAL. REFER TO 5,6,8,9/A-3.1
- (N) 1" THK. SAFETY PADDING TO MATCH (E) @ (E) CMU WALL
- (N) 1" THK. SAFETY PADDING FOR FLOOR, ENTIRE ROOM
- COMBI UNIT INFILL PANEL, FRONT AND TOP, BY MFR.
- (E) SAFETY PADDING TO REMAIN
- (FUTURE) ROOM I.D. SIGN BY OTHERS, N.I.C., REFER TO 6/-
- PROTECT (E) FLOOR DRAIN @ SAFETY PADDING. REFER TO 7/A-3.1
- PROTECT (E) THRESHOLD @ SAFETY PADDING. REFER TO 10/A-3.1
- (E) INTERCOM TO REMAIN

LEGEND

- [---] DEMOLITION
- [---] (E) CMU WALL
- [---] EXISTING WALL PADDING FINISH TO REMOVE
- [---] NEW WORK
- [---] NEW WALL, NEW FIXTURE
- [---] NEW WALL PADDING FINISH

ARCHITECT STAMP

NOT APPROVED FOR CONSTRUCTION

DATE _____

PROJECT
MARIN COUNTY
CORRECTIONAL FACILITY
BOOKING AREA
BARRIER REMOVAL PROJECT

13 PETER BEHR DRIVE
SAN RAFAEL, CA 94903

DRAWING TITLE

DETOX TANK

SCALE: AS NOTED

JOB NUMBER
20013.00

DRAWING NUMBER


DRAWN BY
T.C.

A-2.3

CHECKED BY
K.W. & S.S.


SHEET NO. _____
OF _____

PROJECT ACCEPTED BY: _____

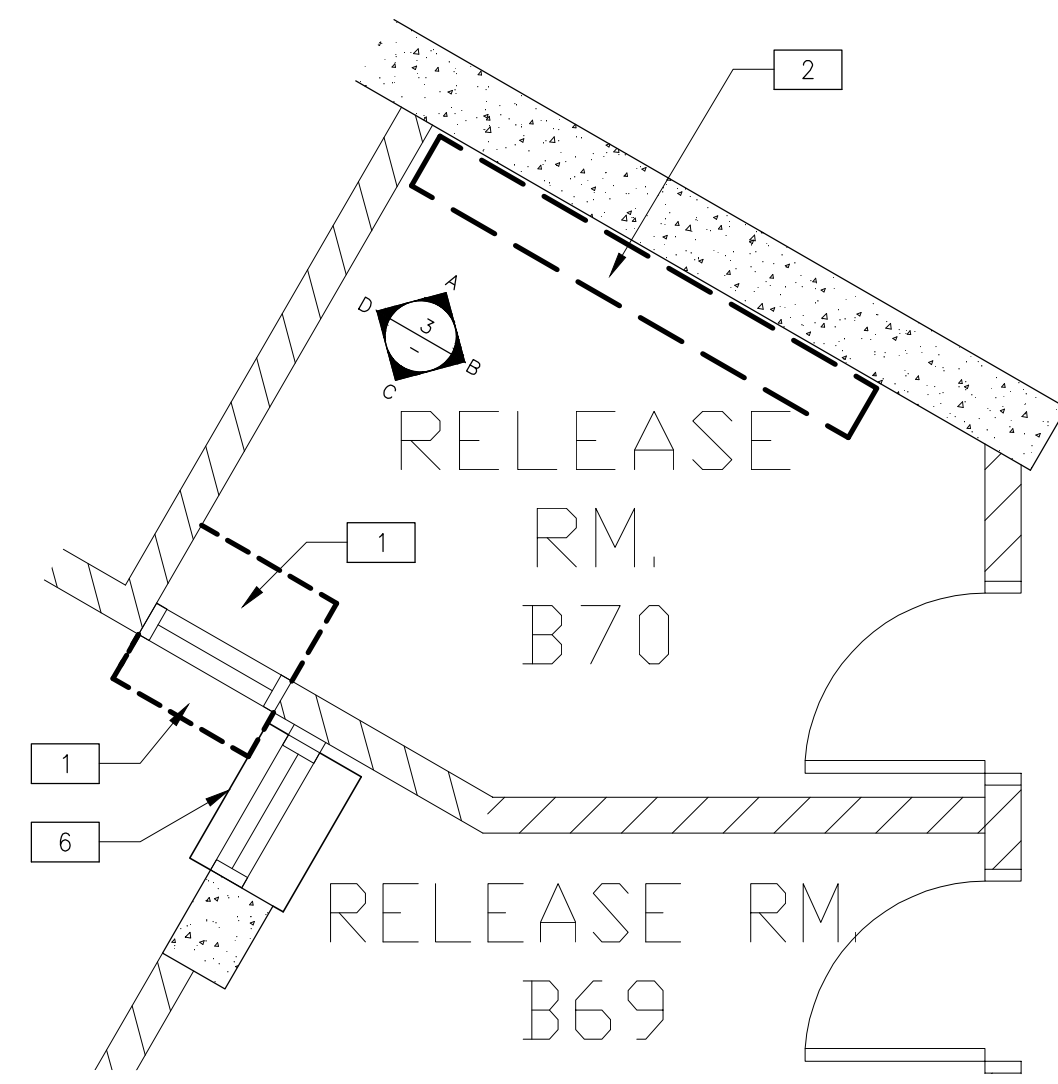

1 DEMO RELEASE ROOM FLOOR PLAN

SCALE: 3/8"=1'-0"

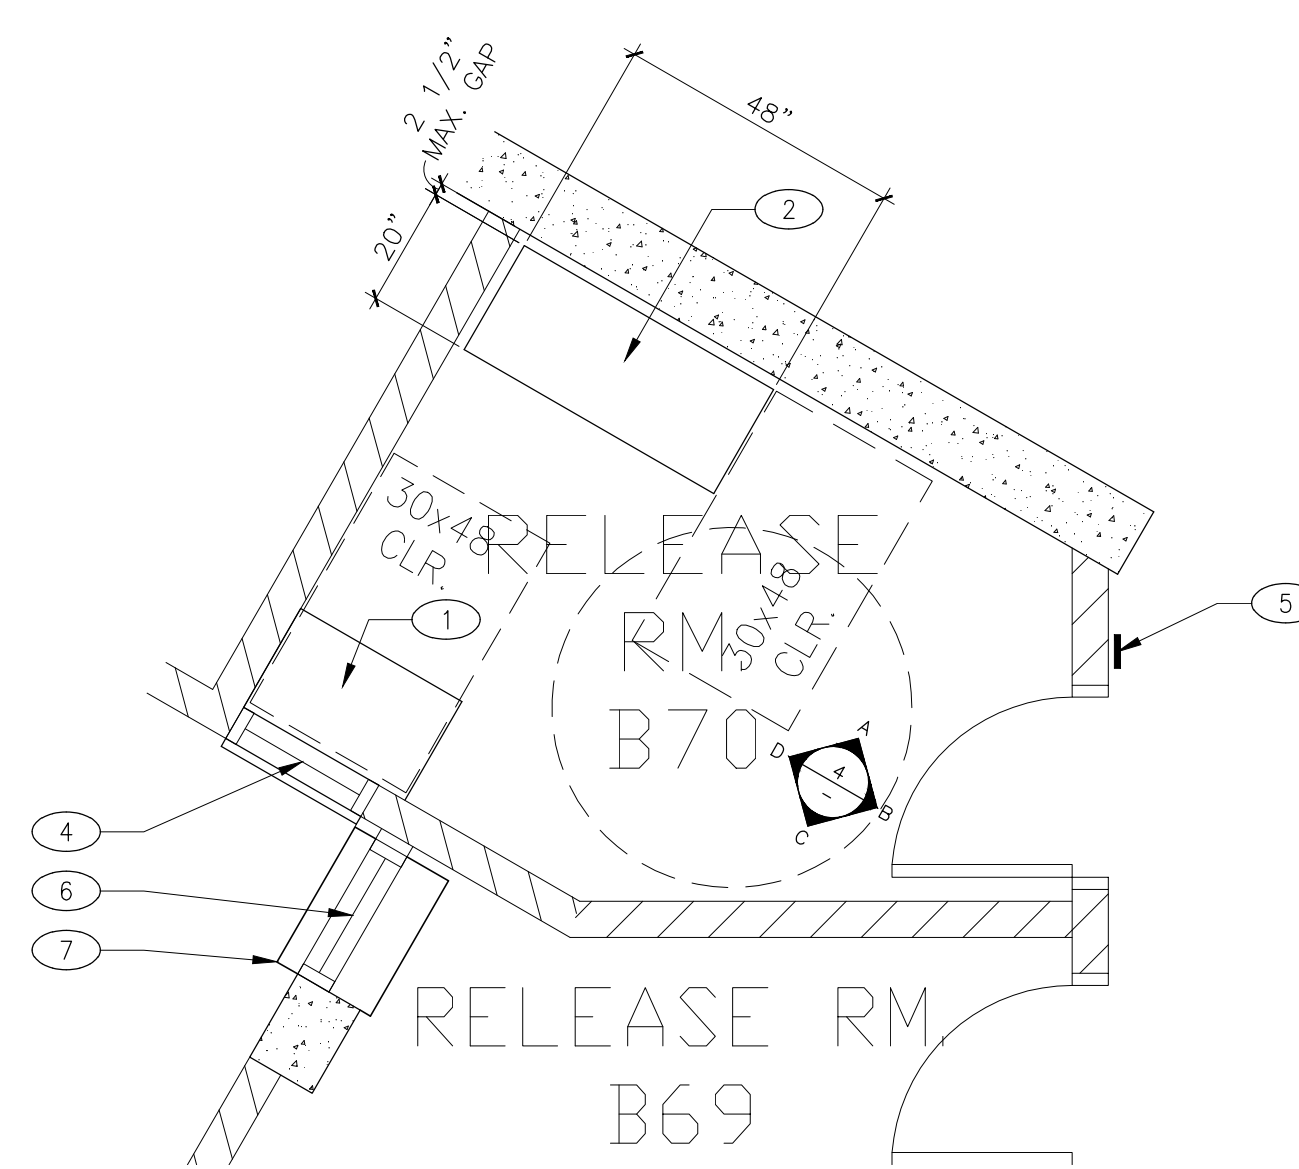

2 NEW RELEASE ROOM FLOOR PLAN

SCALE: 3/8"=1'-0"

PLAN & ELEVATION NOTES

- COORDINATE DEMOLITION WITH NEW CONSTRUCTION DRAWINGS FOR DEMOLITION, SALVAGE, PROTECTION AND RESTORATION OF (E) ITEMS. CONTRACTOR SHALL VERIFY (E) CONDITION PRIOR TO DEMOLITION COMMENCEMENT. PROCEED WITH CAUTION TO AVOID POSSIBLE (E) UNDERGROUND UTILITY LINES, CONDUIT, PIPING, ETC.
- IF ANY DEMO OF (E) CONC. IS REQ'D, SCAN FOR UTILITIES AND REBAR PRIOR TO WORK.
- PATCH AND REPAIR DEMO WALL FINISH TO MATCH (E).
- PATCH AND REPAIR DEMO CEILING FINISH TO MATCH (E).
- PATCH AND REPAIR DEMO FLOOR FINISH TO MATCH (E).
- EXAMINE ALL FINISH SURFACES AFTER COMPLETION OF WORK AND PROCEED WITH "TOUCH-UP" AS REQUIRED.





No.	DESCRIPTION	DATE
1	SCHEMATIC DESIGN	06-15-2020
2	60% DESIGN DOCUMENTS	07-10-2020
3	95% DESIGN DOCUMENTS	08-07-2020
4	100% DESIGN DOCUMENTS	09-04-2020
5	PLAN CHECK SUBMISSION	09-28-2020



COUNTY OF MARIN, DEPARTMENT OF PUBLIC WORKS
PROJECT ACCEPTED BY:





DEMO KEYNOTES

- 1 REMOVE (E) WINDOW AND COUNTER FOR INSTALLATION OF (N) WINDOW AND COUNTER @ ADA HEIGHT.
- 2 REMOVE (E) BENCH, PATCH WALL & FLOOR
- 3 REMOVE (1) COURSE (E) CMU 26" WIDE (±) @ UNDERSIDE OF COUNTER FOR INSTALLATION OF (N) ADA HEIGHT COUNTER
- 4 REMOVE (E) COUNTER
- 5 REMOVE (E) PLEXIGLASS SHUTTER PASS-THRU
- 6 (E) ADJACENT COUNTER TO REMAIN, PROTECT IN PLACE

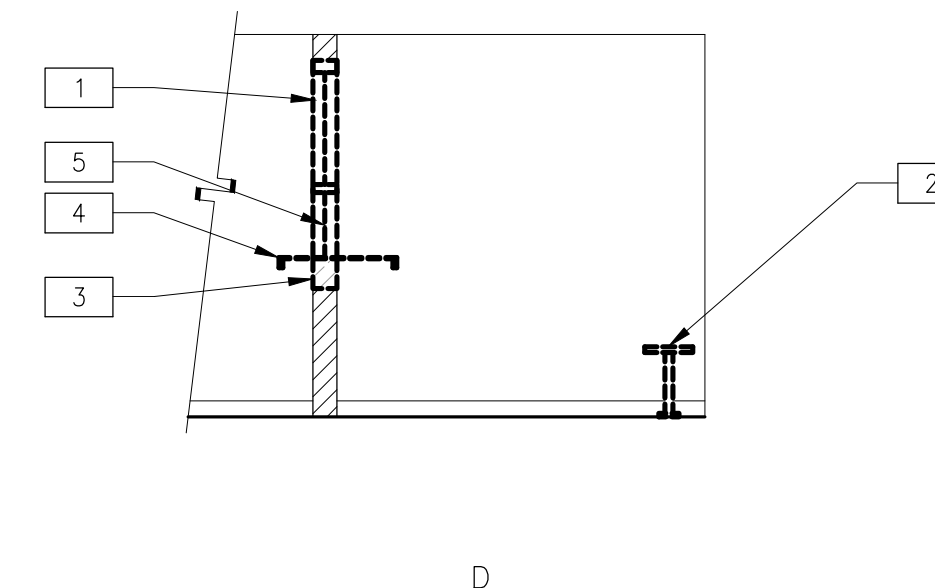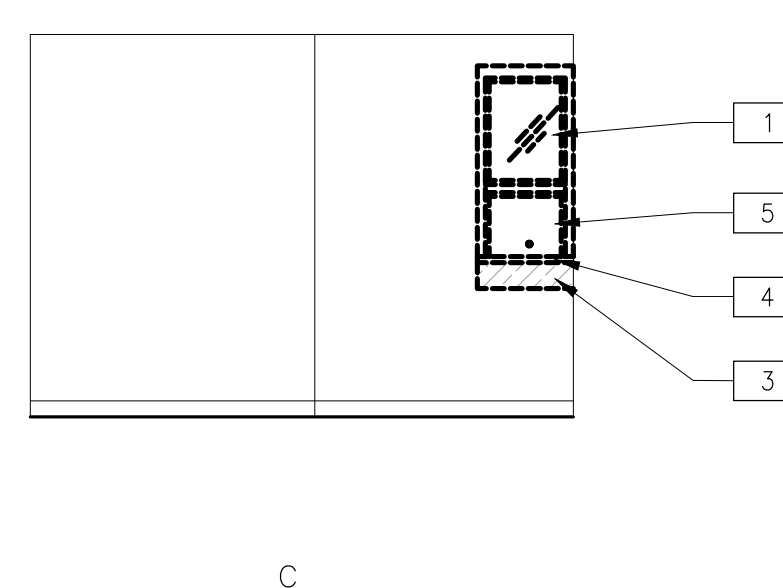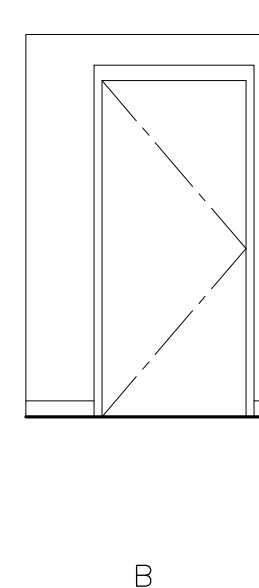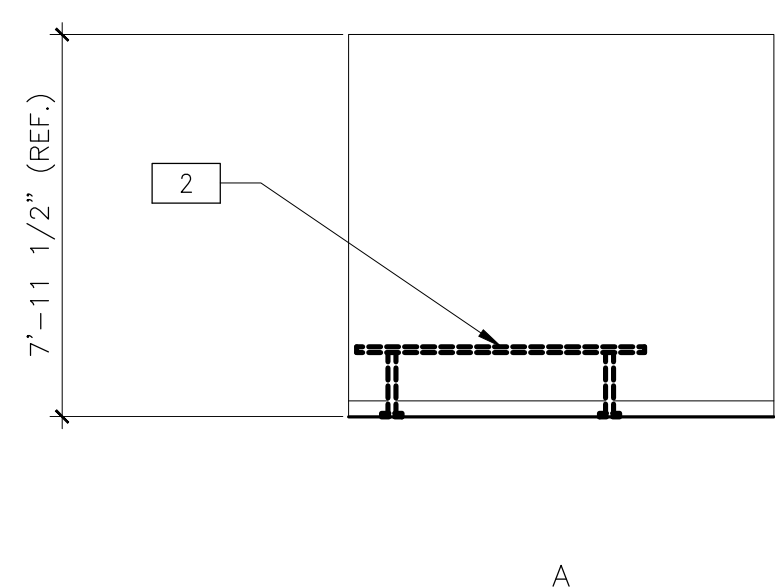

3 DEMO RELEASE ROOM ELEVATIONS

SCALE: 1/4"=1'-0"

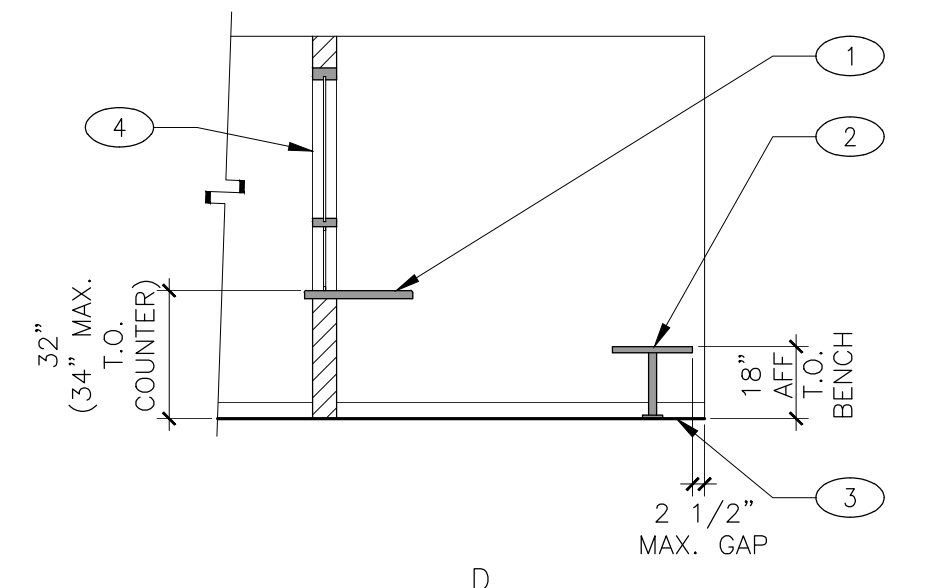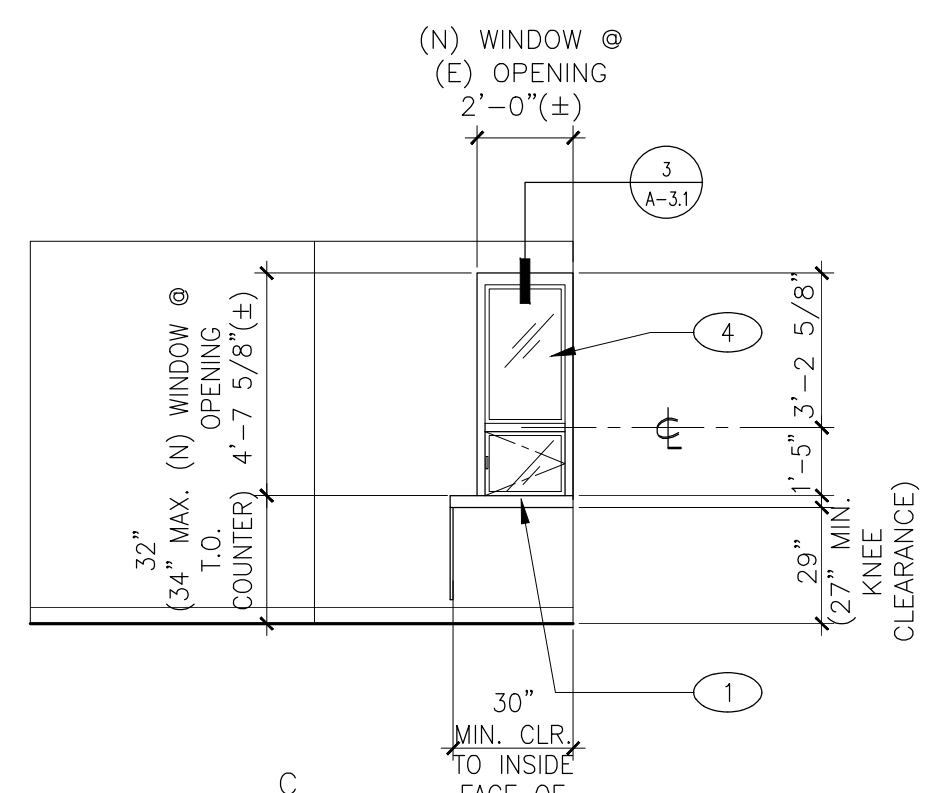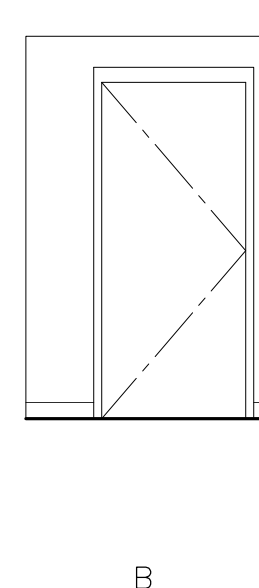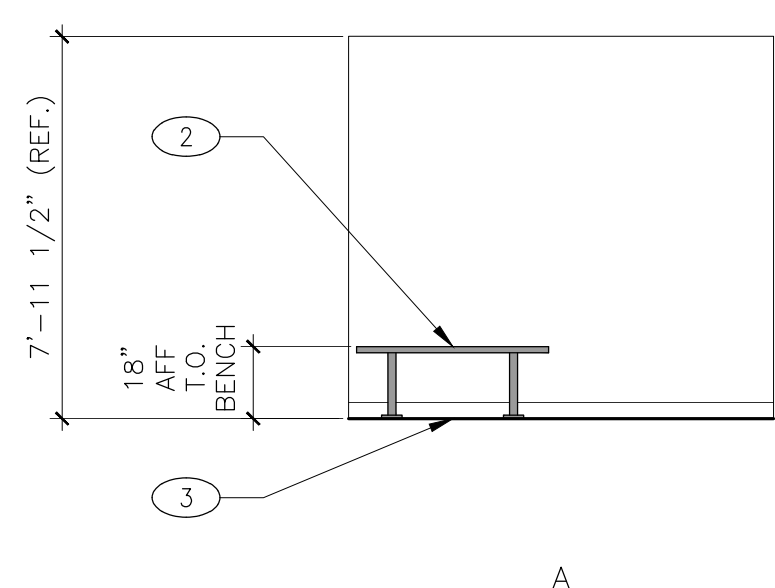

4 NEW RELEASE ROOM ELEVATIONS


SCALE: 1/4"=1'-0"

NEW KEYNOTES

- 1 (N) ADA HEIGHT COUNTER, REFER TO 5/-
- 2 (N) 48"x20" ADA HEIGHT LOCKER BENCH, PEDESTAL MOUNTED
- 3 REPLACE VCT FLOOR AS REQ'D TO MATCH (E) @ REMOVAL OF (E) BENCH FLOOR ATTACHMENT
- 4 (N) WINDOW W/ ALUM. FRAME, FIXED UPPER LITE, LOCKABLE CASEMENT @ LOWER LITE (OPERABLE FROM HALL SIDE) W/ 3/8" CLEAR POLYCARBONATE SECURITY GLAZING @ BOTH LITES, NO MULLION @ SILL TO FACILITATE PASS-THRU OPENING, REFER TO 3/A-3.1
- 5 (FUTURE) ROOM I.D. SIGN BY OTHERS, N.I.C., REFER TO 6/-
- 6 (E) WINDOW & FRAME TO REMAIN, PROTECT IN PLACE
- 7 (E) ADJACENT COUNTER, PROTECT IN PLACE, REFINISH EDGES AS NEEDED


(FUTURE) SIGNAGE NOTES:

- CHARACTERS, SYMBOLS AND THEIR BACKGROUND SHALL HAVE A NON-GLARE FINISH. CHARACTERS AND SYMBOLS CONTRAST WITH THEIR BACKGROUND. EITHER LIGHT CHARACTERS ON A DARK BACKGROUND OR DARK CHARACTERS ON A LIGHT BACKGROUND. (CBC 11B-703.5.1)
- CHARACTERS ON SIGNS SHALL BE SELECTED FROM FONTS WHERE THE WIDTH OF THE UPPER CASE LETTER "O" IS 60% MIN. AND 110% MAX. OF THE HEIGHT OF THE UPPER CASE LETTER "I" AND A STROKE THICKNESS OF THE UPPER CASE LETTER "I" SHALL BE 15% MAX. OF THE HEIGHT OF THE CHARACTER.
- VISUAL CHARACTERS AND NUMBERS ON SIGNS SHALL BE SIZED ACCORDING TO THE VIEW DISTANCE FROM WHICH THEY ARE TO BE READ. THE MIN. HEIGHT IS MEASURED USING AN UPPER CASE "I". LOWERCASE CHARACTERS ARE PERMITTED. FOR SIGNS SUSPENDED OR PROJECTED ABOVE THE FINISH FLOOR IN COMPLIANCE WITH CBC SECTION 11B-703.5.5, THE MIN. CHARACTER HEIGHT SHALL BE 5/8" (15.9MM). REFER TO ACCOMPANYING DETAILS FOR CHARACTER HEIGHT.
- CHARACTERS ON SIGNS SHALL BE RAISED 1/32" (0.794 MM) MIN. AND SHALL BE SANS SERIF UPPERCASE CHARACTERS ACCOMPANIED BY GRAD 2 BRAILLE COMPLYING W/ CBC SECTION 11B-703.2 & 11B-703.3.
- RAISED CHARACTERS SHALL BE A MIN. OF 5/8" (15.9 MM) AND A MAX. OF 2" (51 MM) HIGH (CBC SECTION 11B-1117B.5.5). REFER TO ACCOMPANYING DETAILS FOR CHARACTER HEIGHT.
- PICTORIAL SYMBOL SIGNS (PICTOGRAMS) SHALL BE ACCOMPANIED BY THE VERBAL DESCRIPTION PLACED DIRECTLY BELOW THE PICTOGRAM. THE OUTSIDE DIMENSION OF THE PICTOGRAM FIELD SHALL BE A MIN. OF 6 INCHES (152 MM) IN HEIGHT (CBC SECTION 11B-703.6.1).
- CONTRACTED CALIFORNIA GRADE 2 BRAILLE. DOT SHALL BE 1/10 INCHES (2.54MM) ON CENTER IN EACH CELL W/ 0.300" 7.62 MM) SPACE BETWEEN CELLS, MEASURED FROM THE SECOND COLUMN OF DOTS IN THE FIRST CELL TO THE FIRST COLUMN OF DOTS IN THE SECOND CELL. DOTS SHALL BE RAISED A MIN. OF 1/40 INCH (0.635 MM) ABOVE THE BACKGROUND (CBC 11B-1117B.5.6).
- WHERE PERMANENT IDENTIFICATION IS PROVIDED FOR ROOMS AND SPACES, SIGN SHALL BE INSTALLED ON THE WALL ADJACENT TO THE LATCH OUTSIDE OF THE DOOR AS INDICATED ON THE ACCOMPANYING DETAIL(S). WHERE THERE IS NO WALL SPACE ON THE LATCH SIDE INCLUDING AT DOUBLE-LEAF DOORS, SIGN SHALL BE PLACED ON THE NEAREST ADJACENT WALL, PREFERABLY ON THE RIGHT, SIGNS SHALL BE LOCATED 48" MIN. A.F.F. OR GROUND SURFACE AS MEASURED FROM THE BASELINE OF THE LOWEST BRAILLE CELLS AND 60" MAX. A.F.F. OR GROUND SURFACE AS MEASURED TO THE BASELINE OF HIGHEST LINE OF RAISED CHARACTERS (11B-703.4.1). SIGNS CONTAINING TACTILE CHARACTERS SHALL BE LOCATED SO THAT A CLEAR FLOOR SPACE OF 18" MIN. x 18" MIN. CENTERED ON THE TACTILE CHARACTERS IS PROVIDED BEYOND THE ARC OF ANY DOOR SWING BETWEEN THE CLOSED POSITION AND 45° OPEN POSITION.
- THE INTERNATIONAL SYMBOL OF ACCESSIBILITY (ISA) SHALL BE THE STANDARD USED TO IDENTIFY FACILITIES THAT ARE ACCESSIBLE TO AND USABLE BY PHYSICALLY DISABLED PERSON. THE SYMBOL SHALL CONSIST OF A WHITE FIGURE ON A BLUE BACKGROUND. THE BLUE SHALL BE EQUAL TO COLOR No. 15090 IN FEDERAL STANDARD 595C.

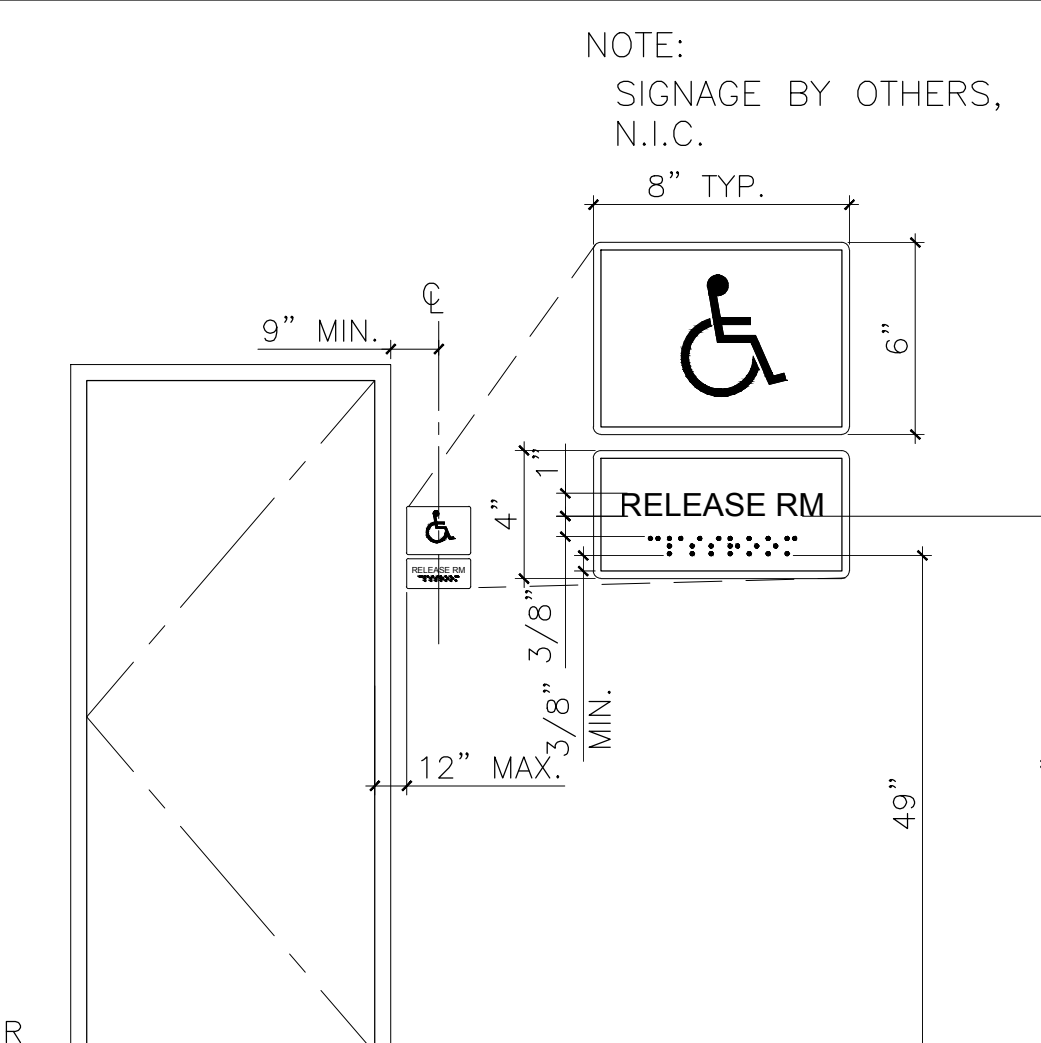

6 (FUTURE) ROOM SIGNAGE MOUNTING LOCATION

SCALE: 1/2"=1'-0"

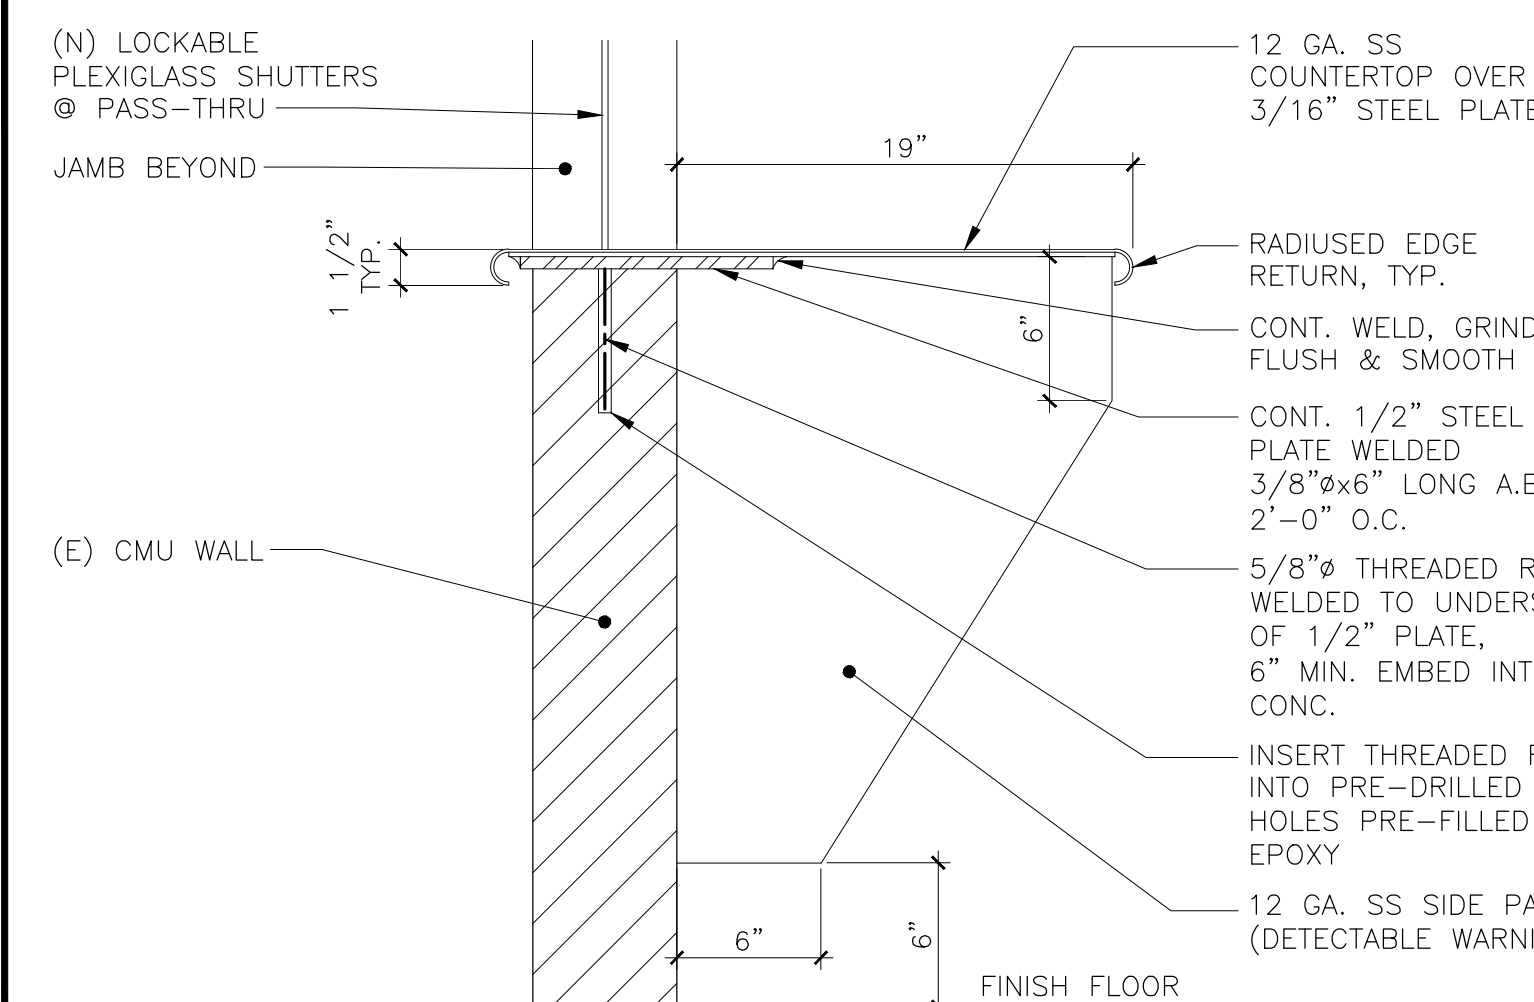

5 RELEASE ROOM COUNTER

SCALE: 1 1/2"=1'-0"

LEGEND

- [---] DEMOLITION
- [---] (E) CMU WALL
- [---] (E) CONC. WALL
- [---] NEW WORK
- [---] NEW WALL OR NEW FIXTURE

Sally Swanson Architects, Inc.

SSA
 500 Sansome St, Suite 410
 San Francisco, CA 94111
 Tel: 415.445.3045
 Fax: 415.445.3055
 ssa@swanarch.com

Architecture
 Planning
 Accessible Design

ARCHITECT STAMP


NOT APPROVED FOR CONSTRUCTION

DATE _____


PROJECT: MARIN COUNTY CORRECTIONAL FACILITY BOOKING AREA BARRIER REMOVAL PROJECT

DRAWING TITLE: **RELEASE ROOM**


SCALE: AS NOTED	DRAWING NUMBER
JOB NUMBER 20013.00	A-2.4
DRAWN BY T.C.	CHECKED BY K.W. & S.S.
SHEET NO. _____	OF _____

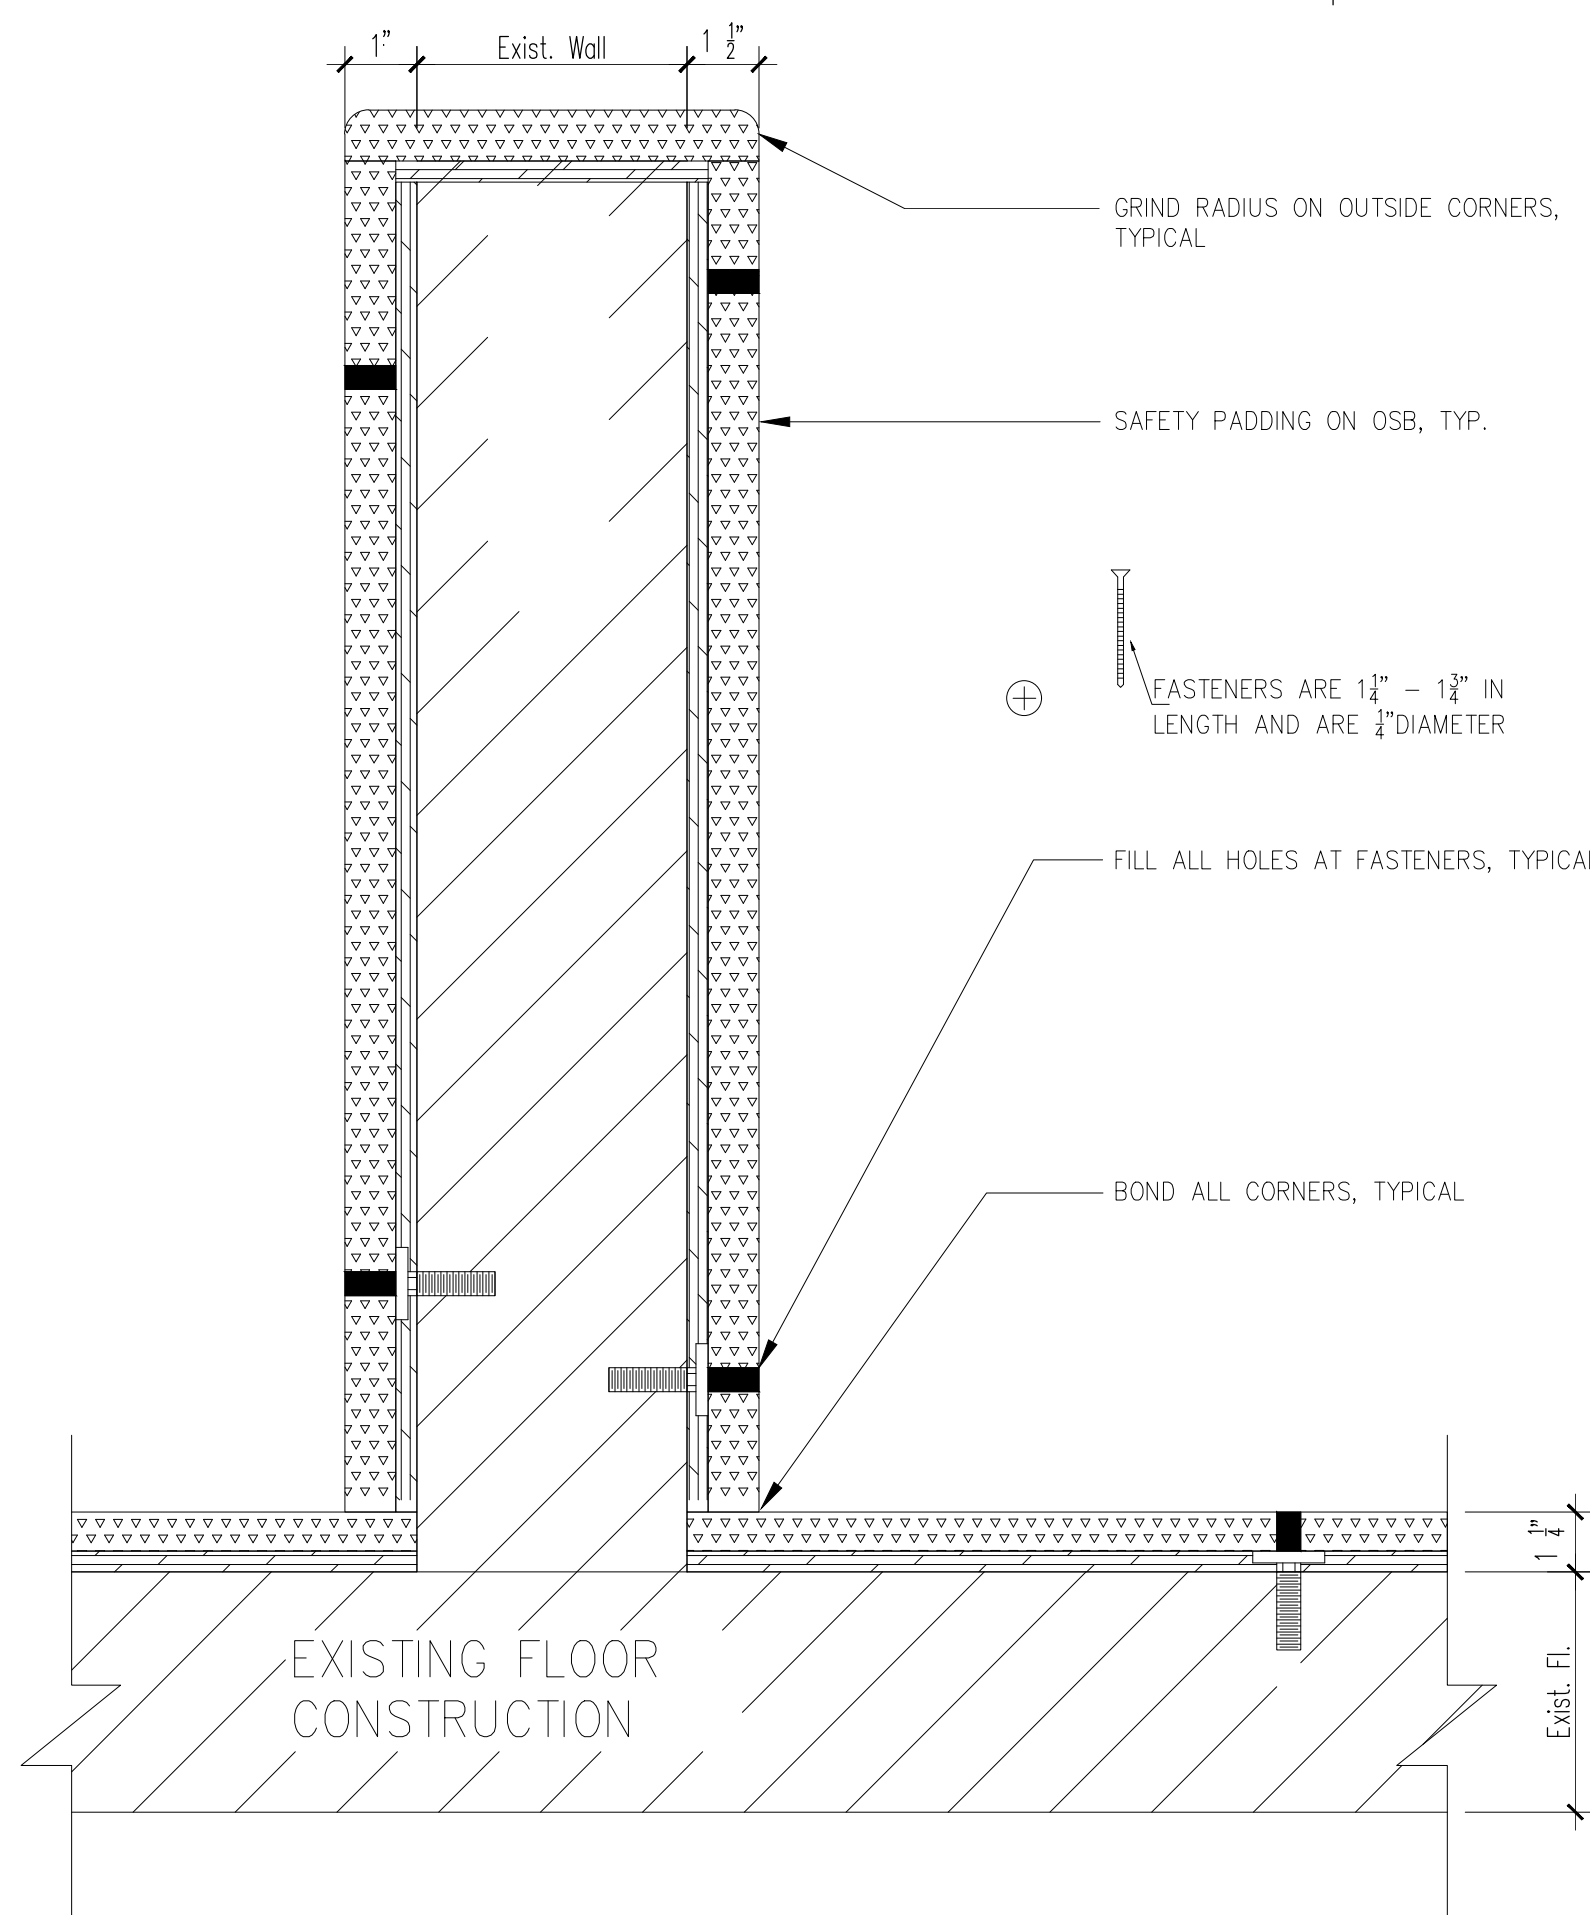


11 SAFETY PADDING PONY WALL SCALE: 3"=1'-0"

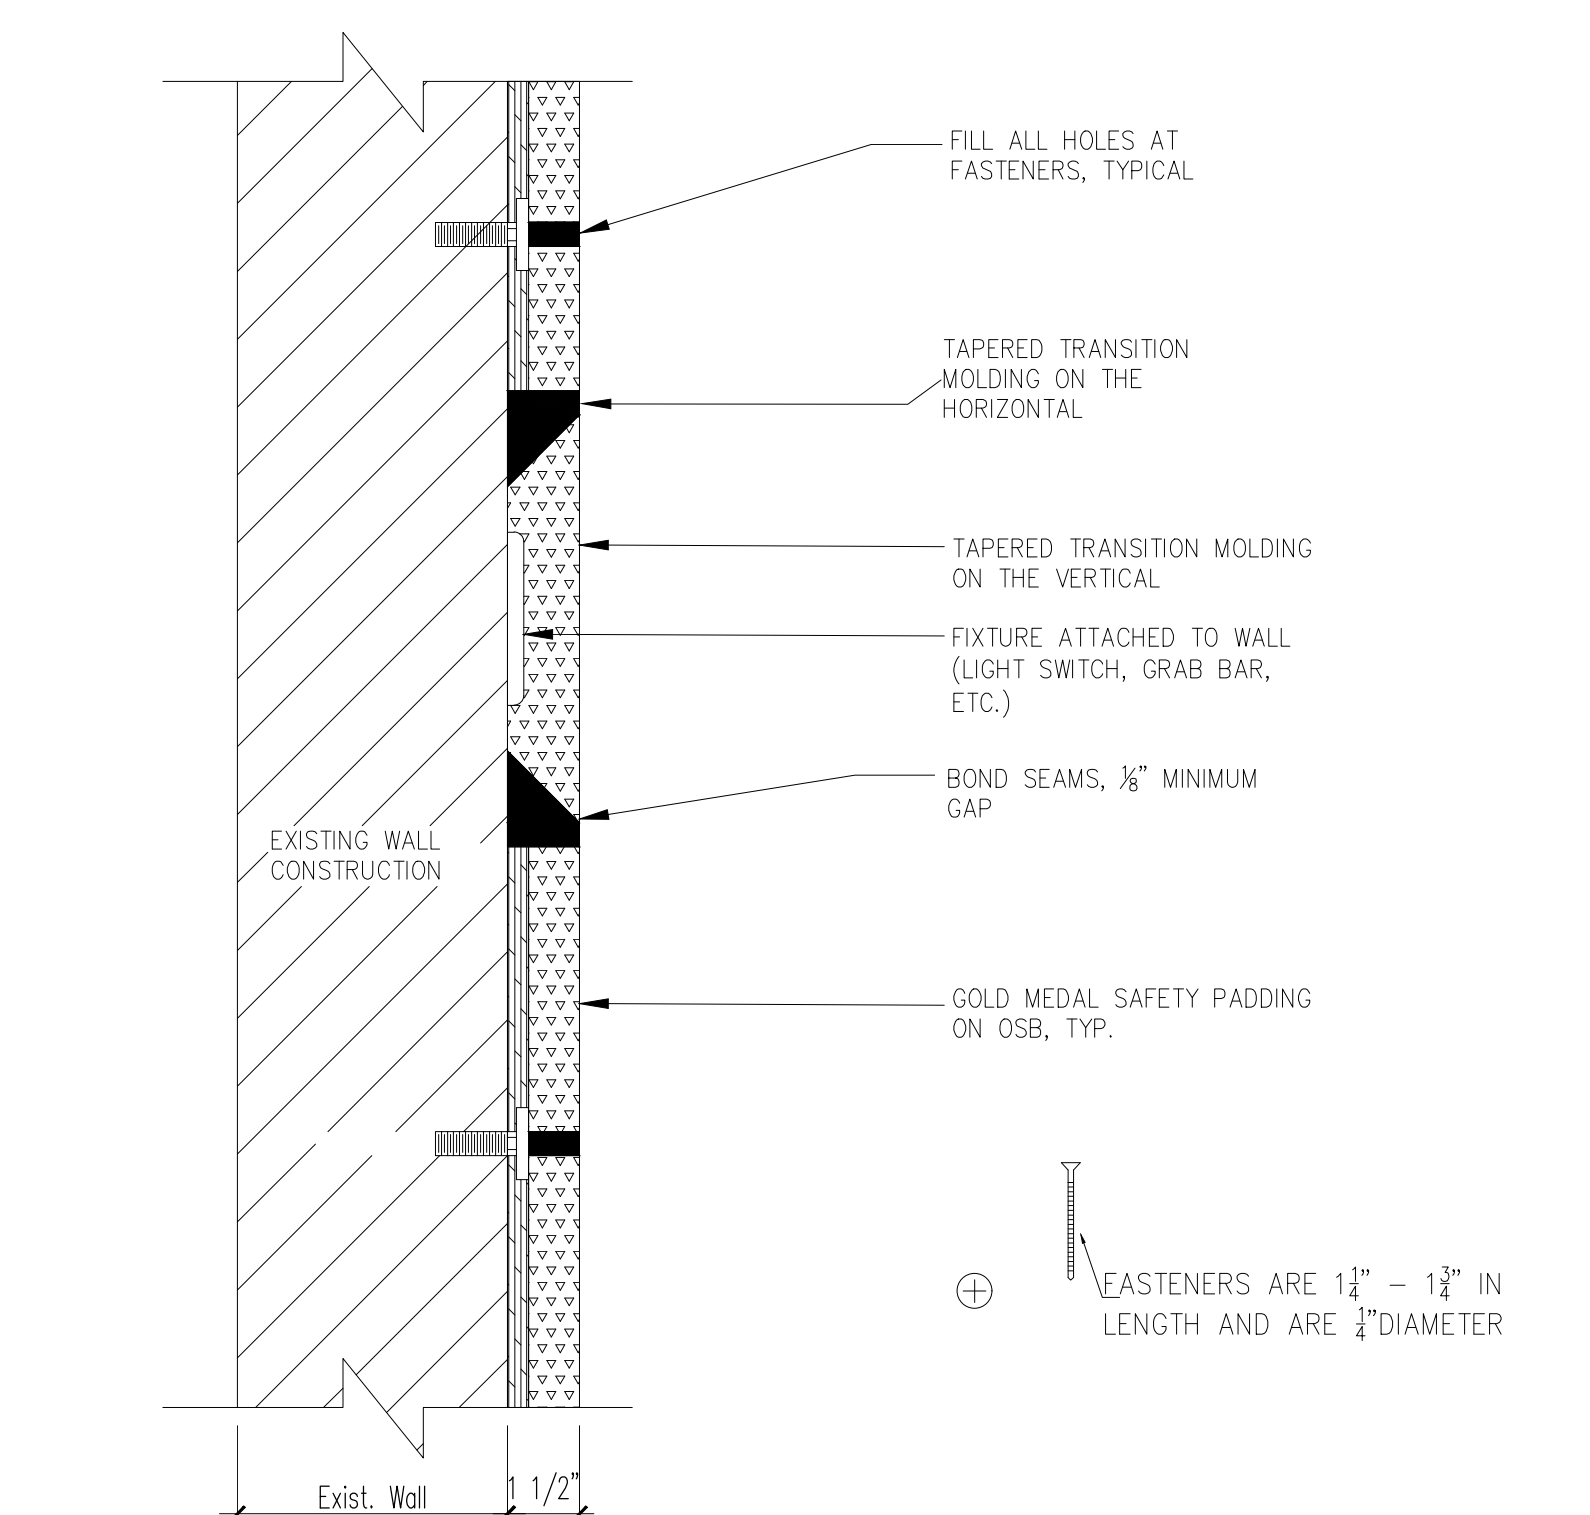


12 SAFETY PADDING WALL FIXTURE SCALE: 3"=1'-0"

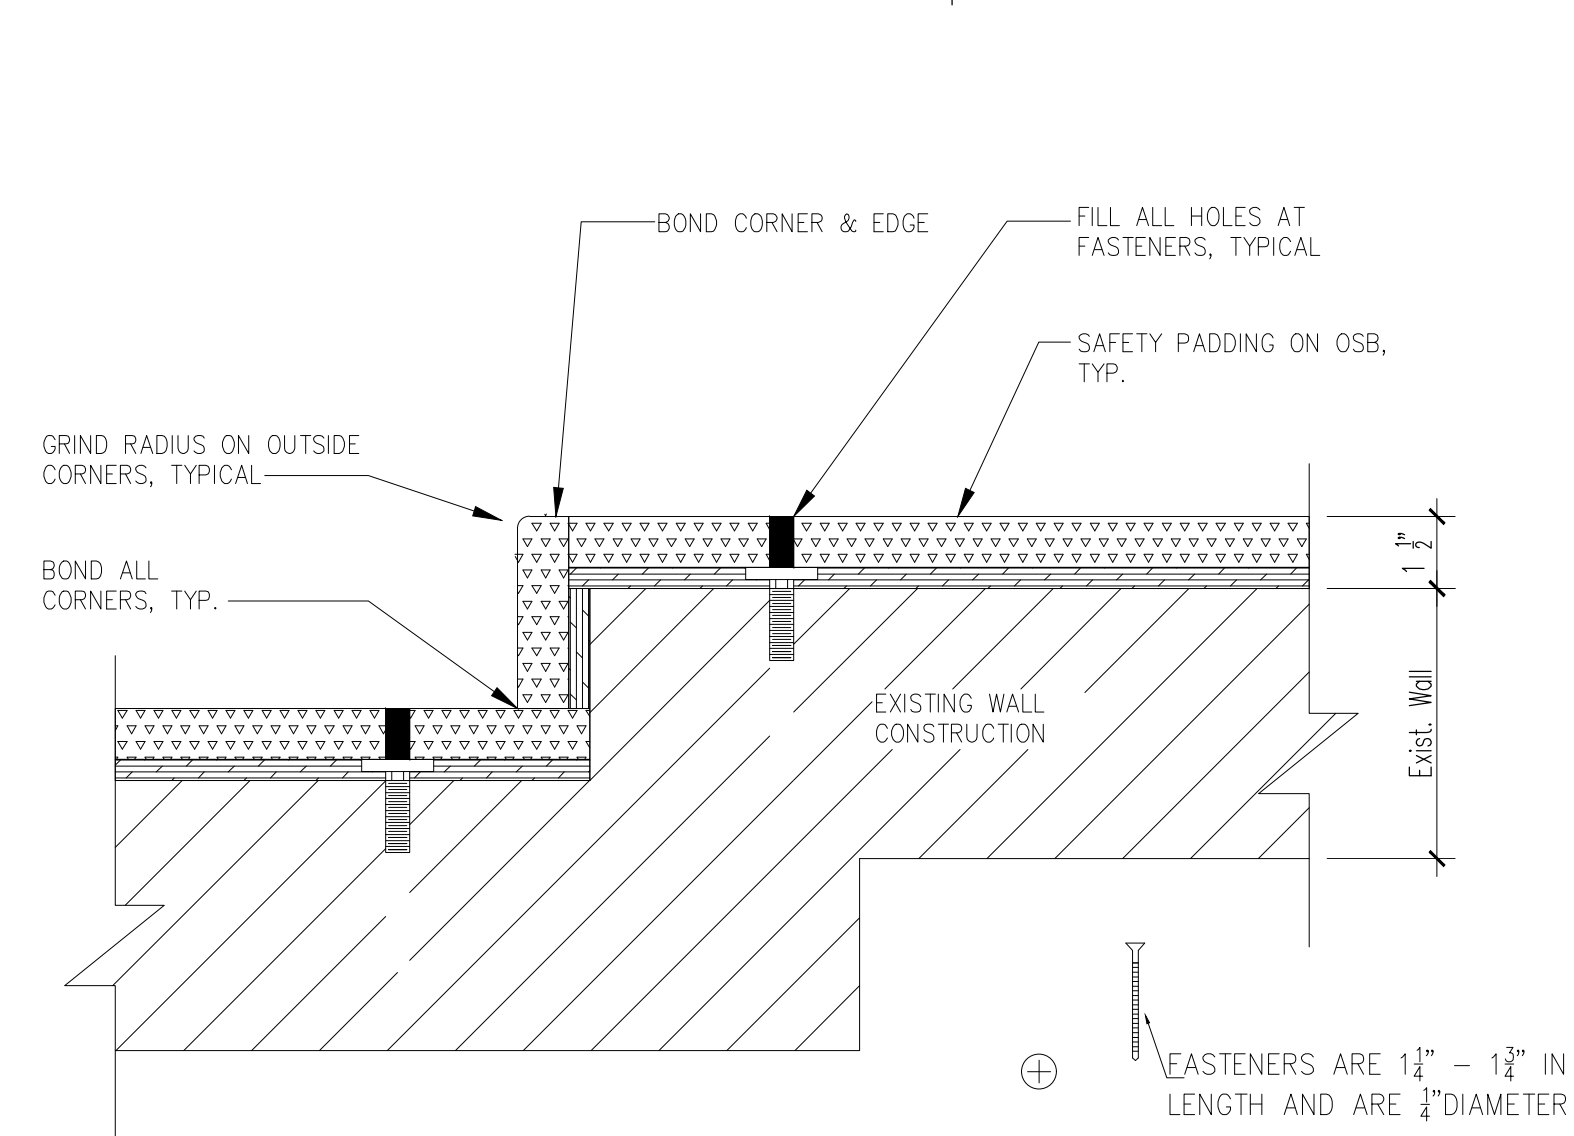


8 SAFETY PADDING OUTSIDE CORNER SCALE: 3"=1'-0"

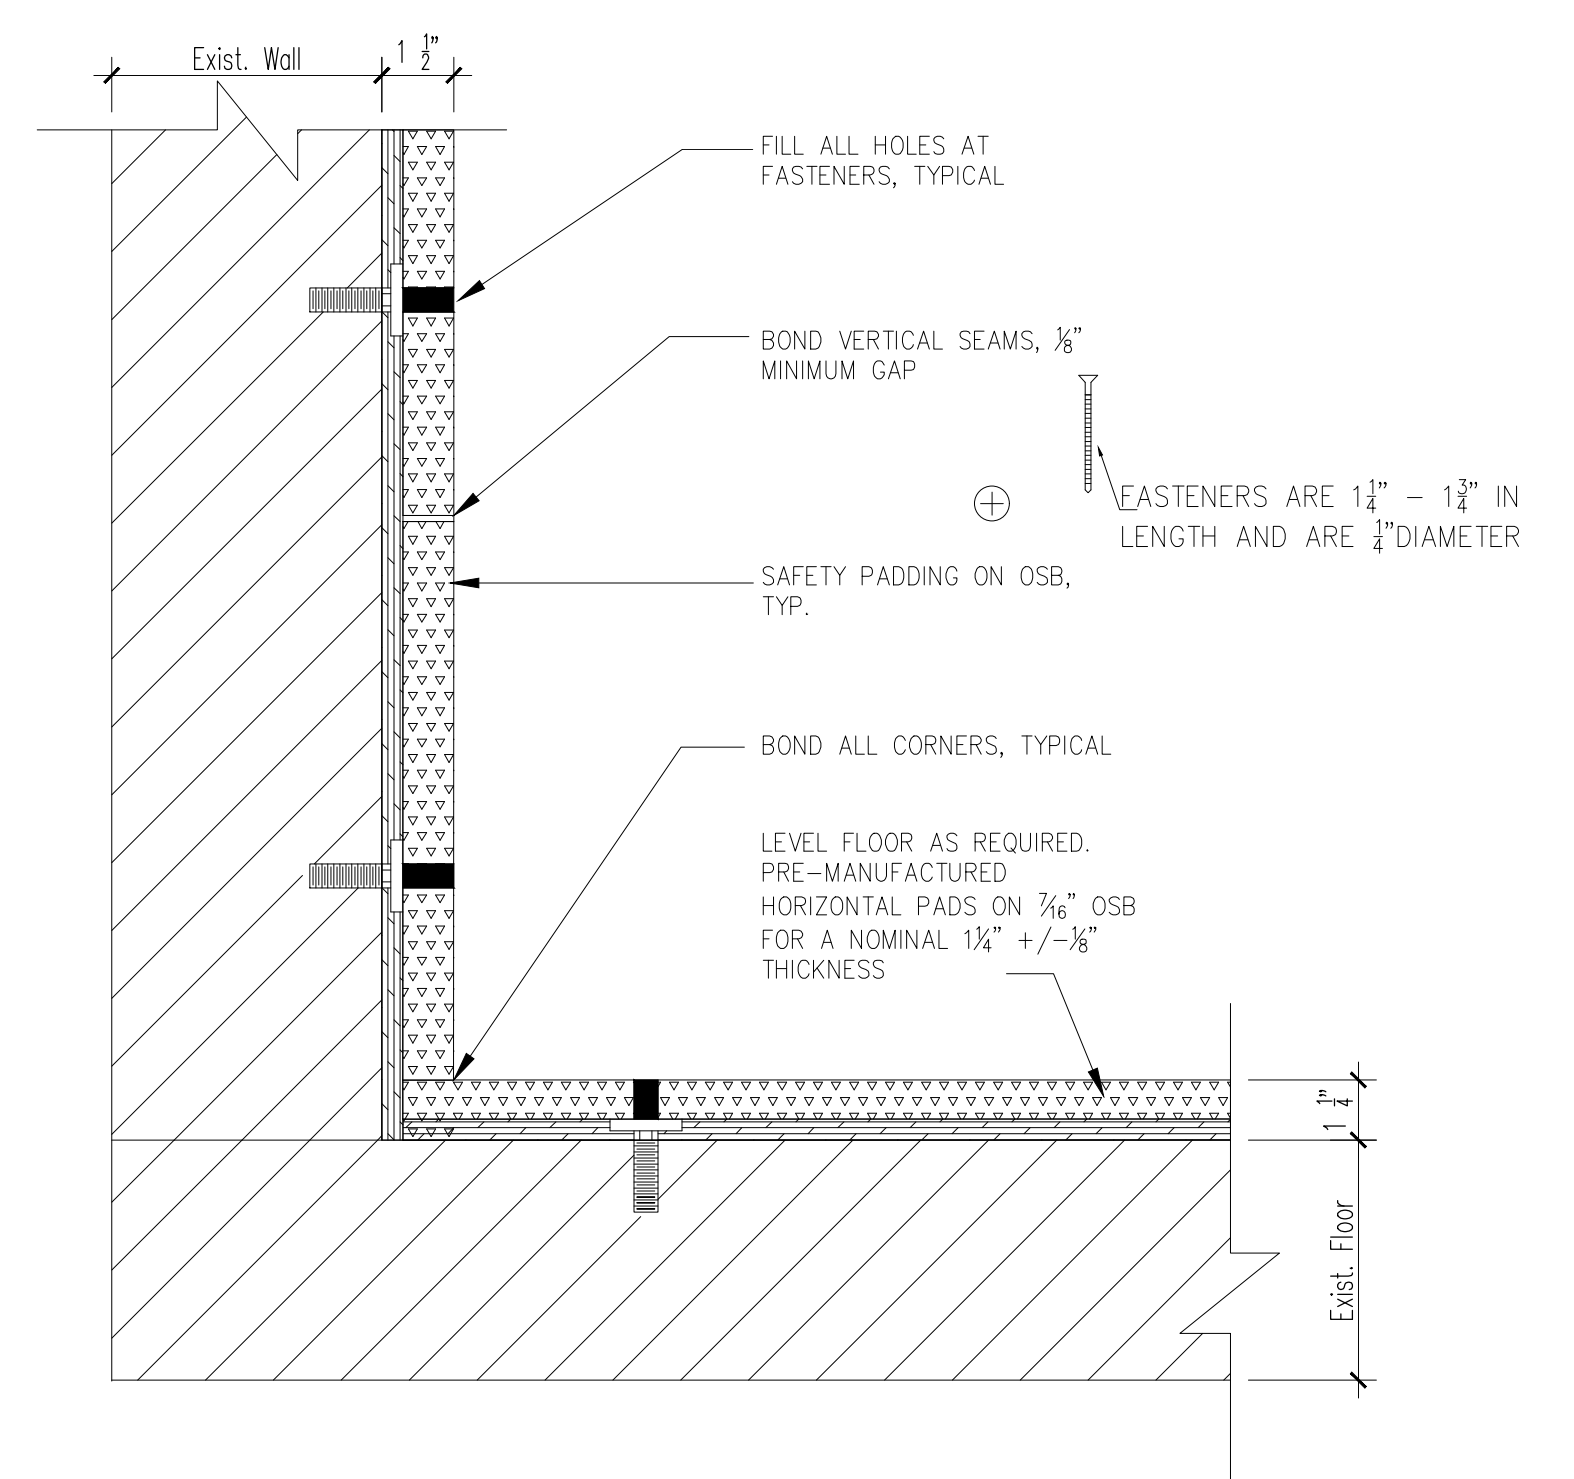


9 SAFETY PADDING WALL TO FLOOR SCALE: 3"=1'-0"

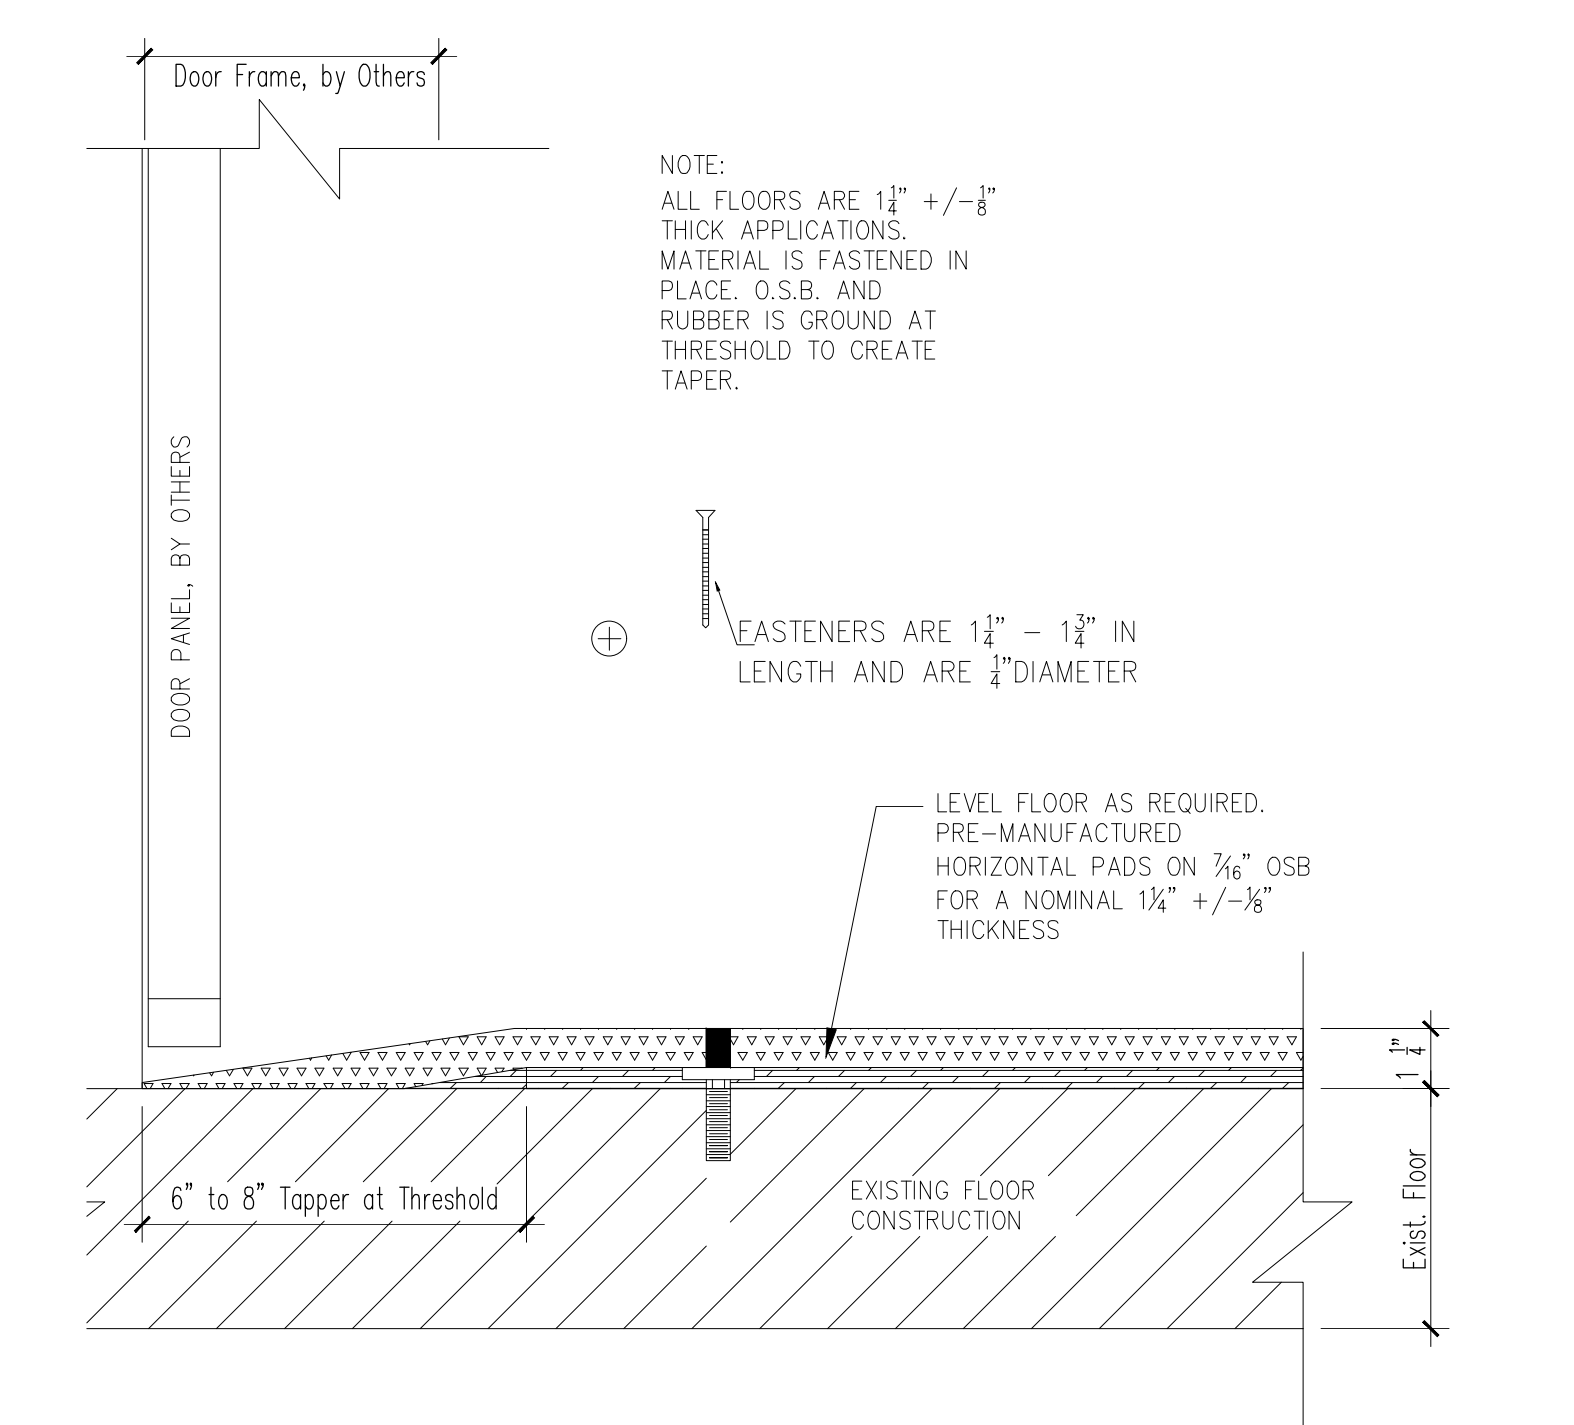


10 SAFETY PADDING THRESHOLD SCALE: 3"=1'-0"

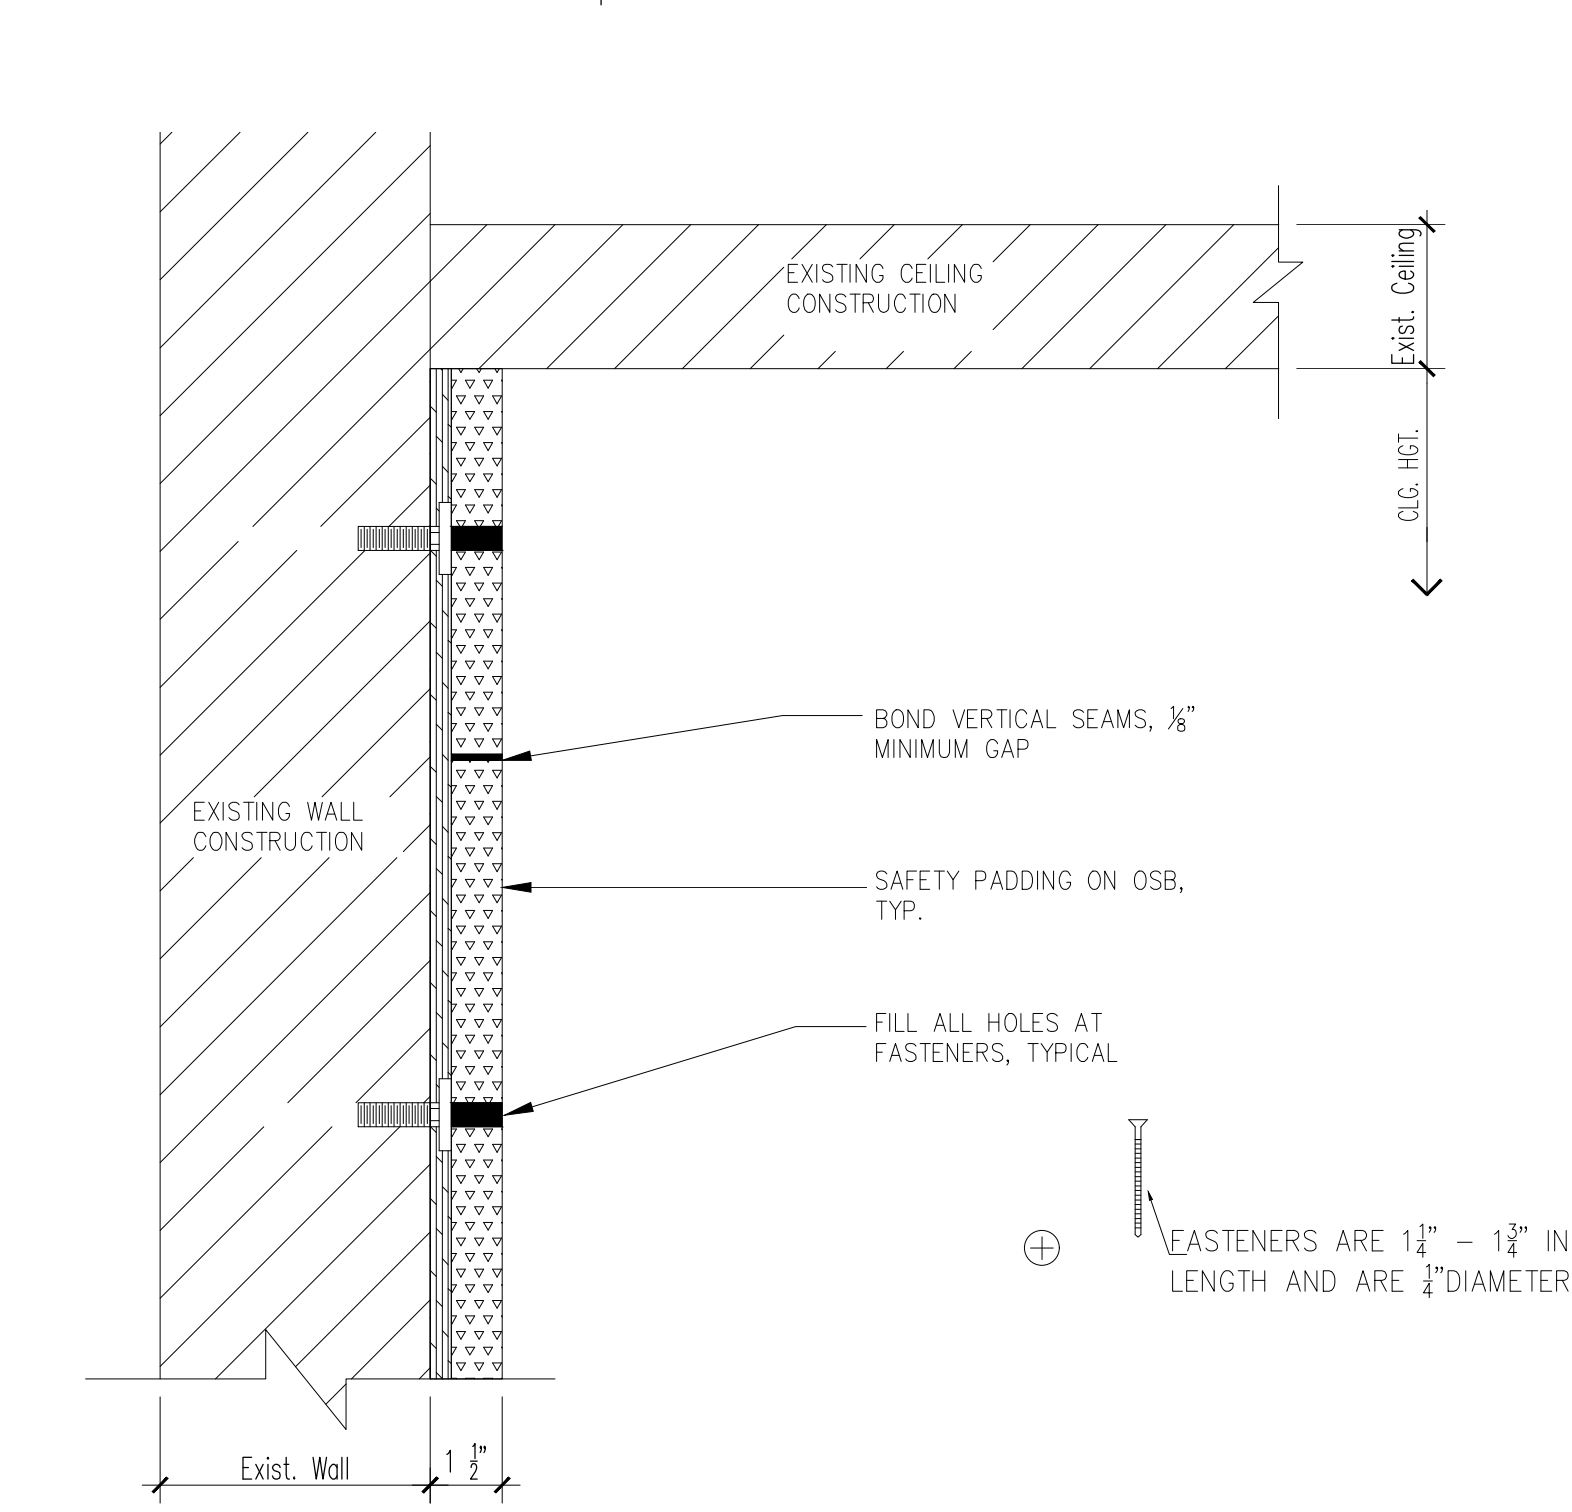


5 SAFETY PADDING WALL TO CEILING SCALE: 3"=1'-0"

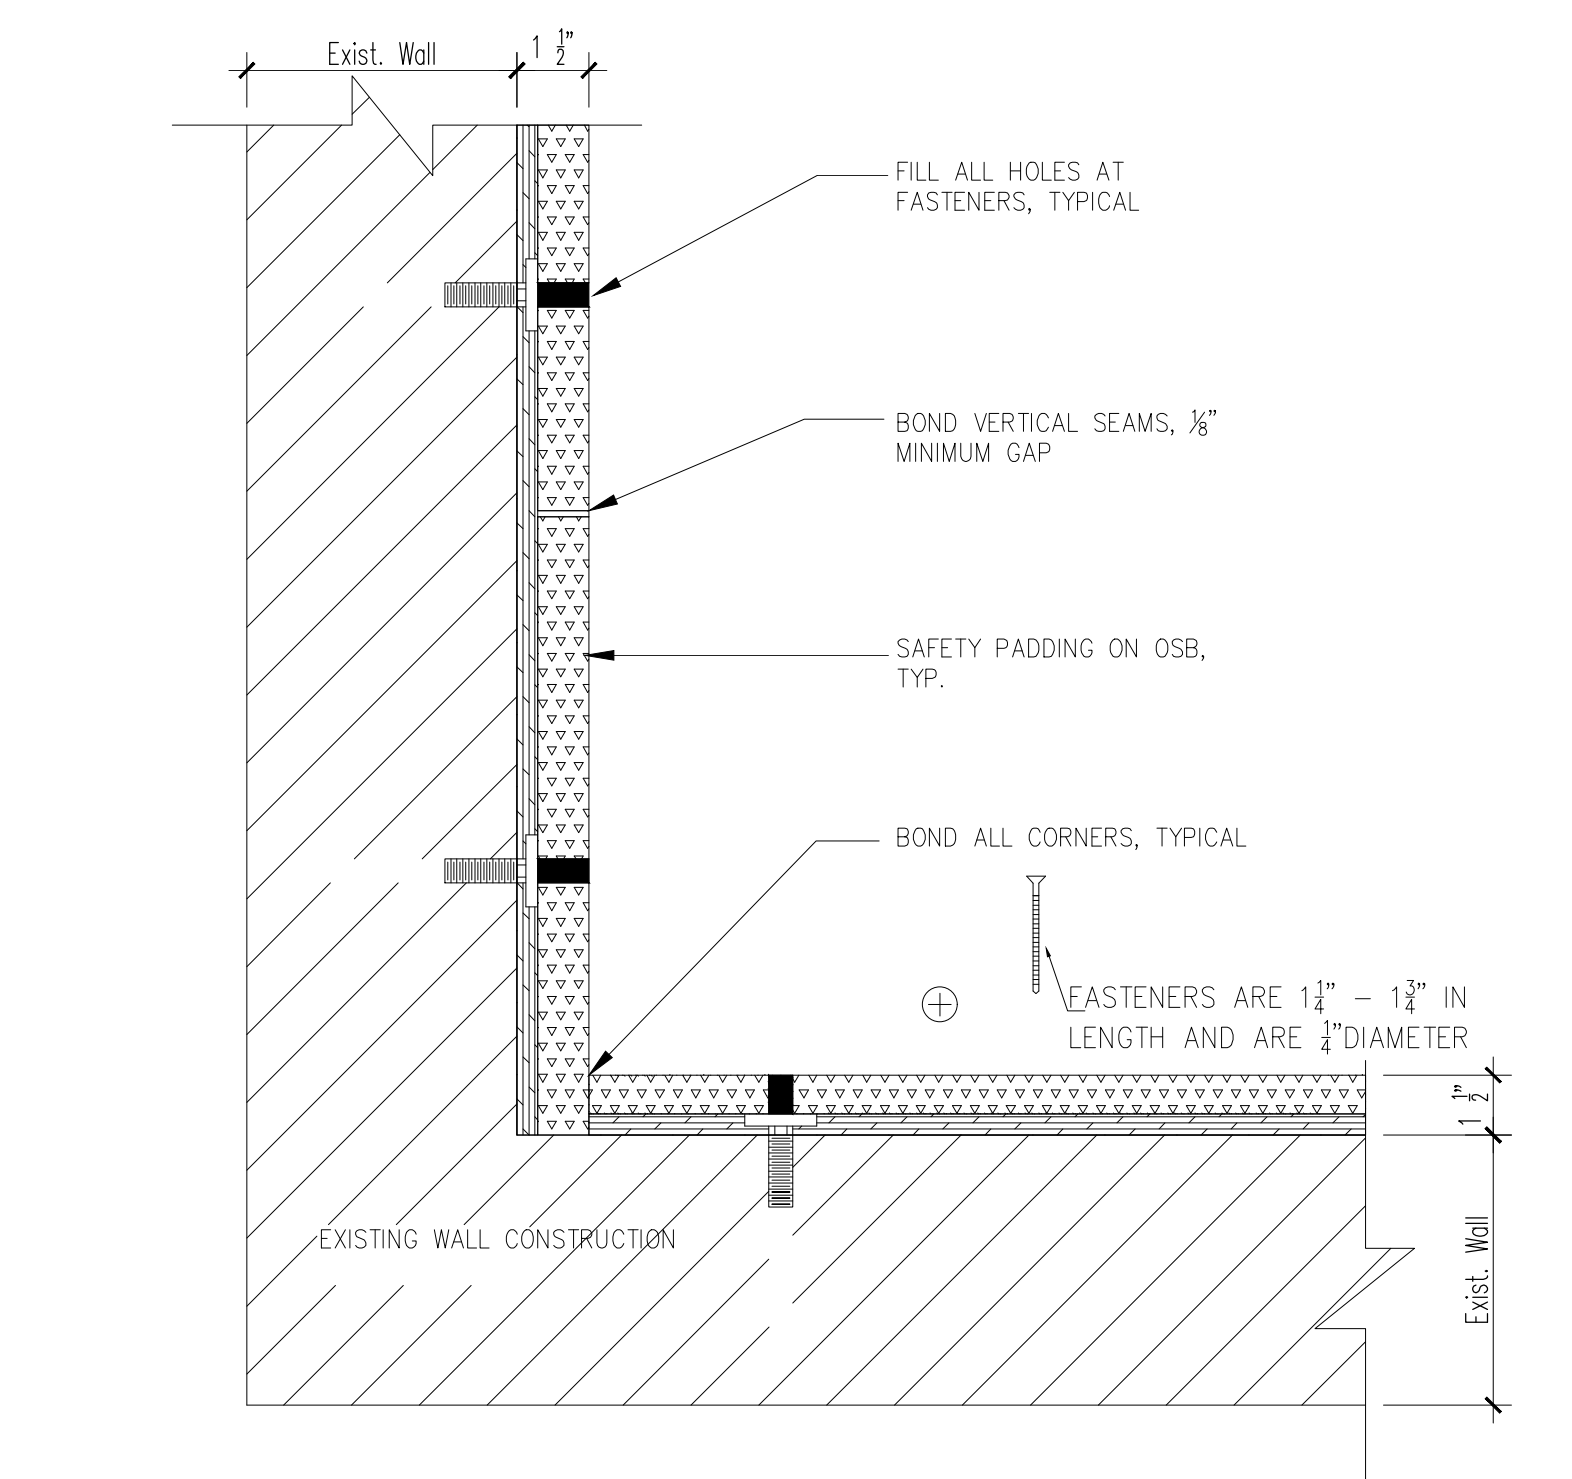


6 SAFETY PADDING INSIDE CORNER SCALE: 3"=1'-0"

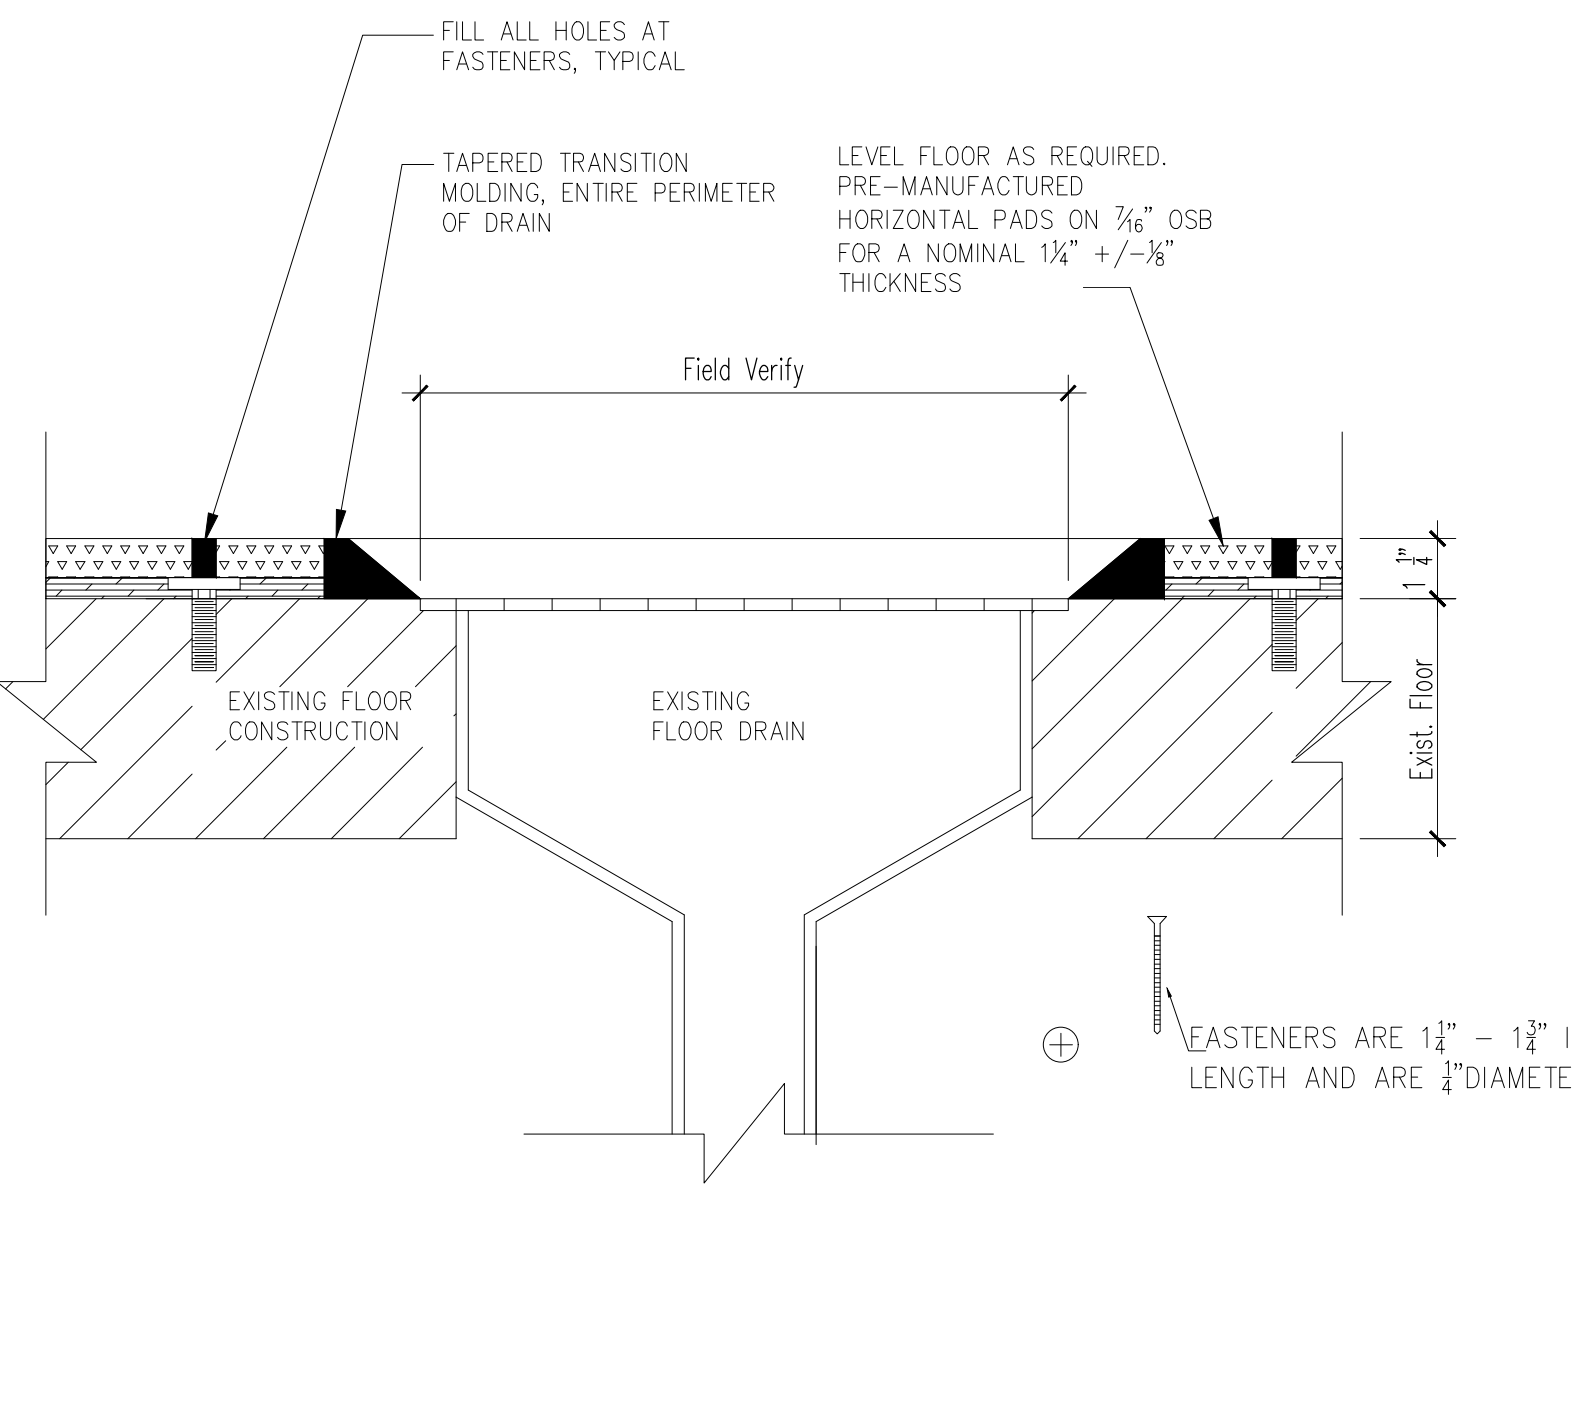


7 SAFETY PADDING FLOOR DRAIN SCALE: 3"=1'-0"

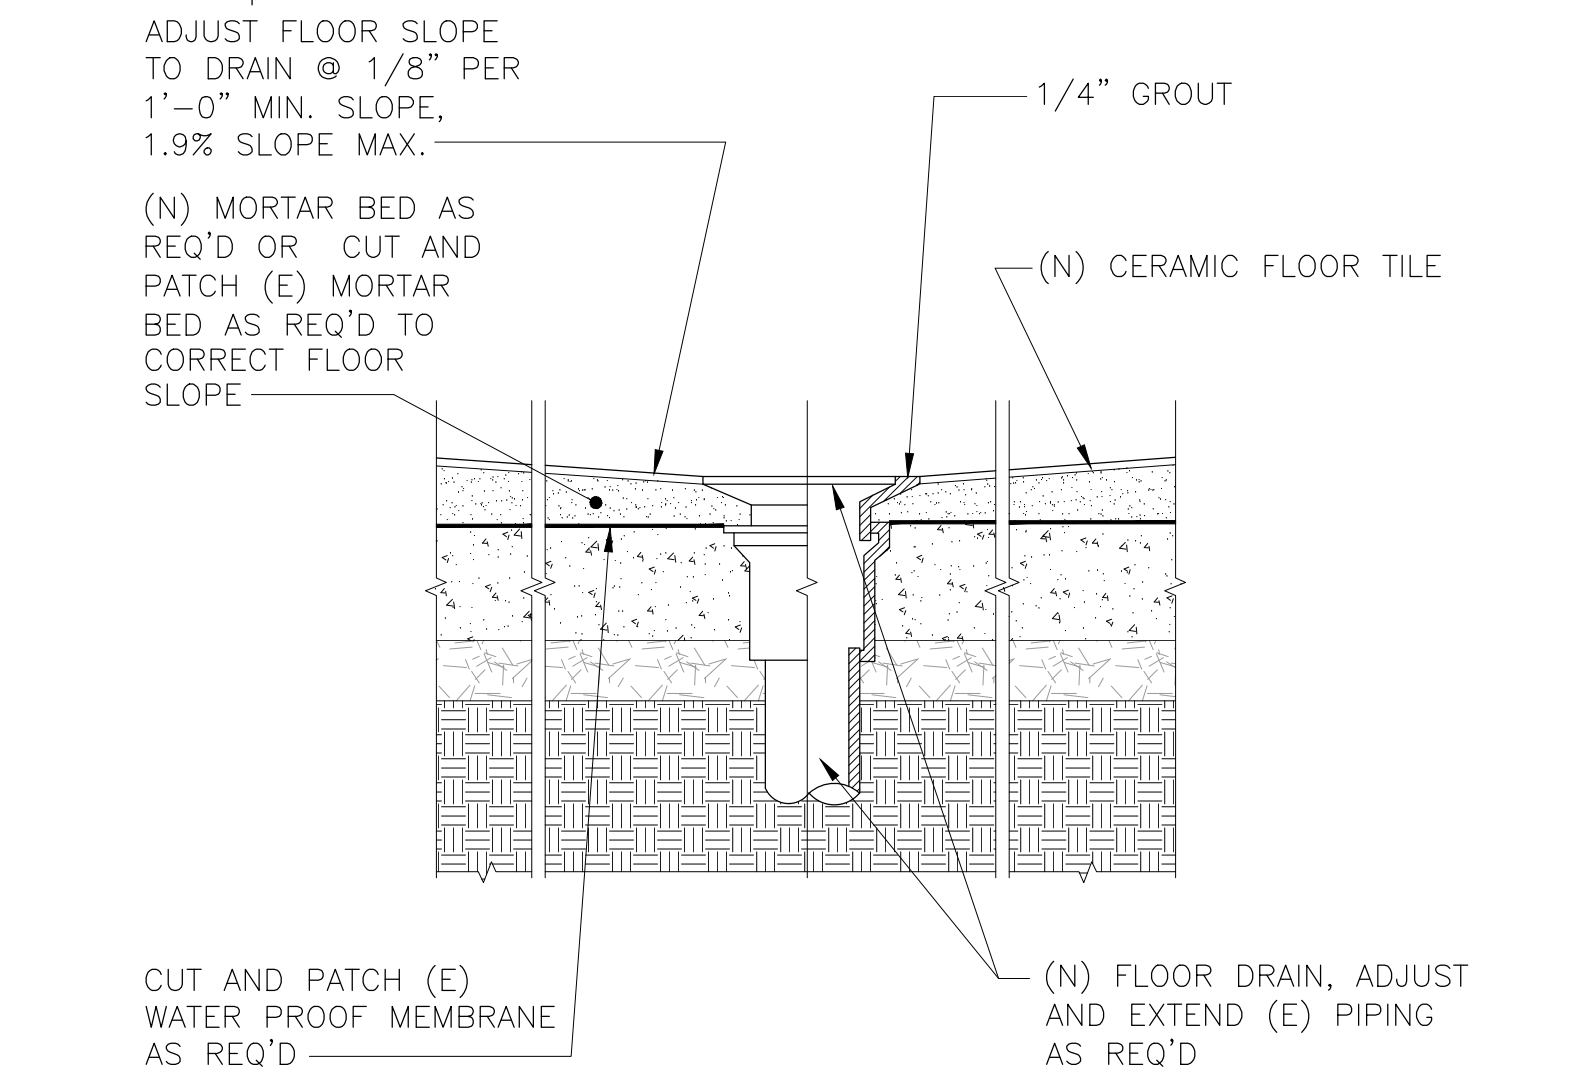


1 FLOOR DRAIN SCALE: 3"=1'-0"

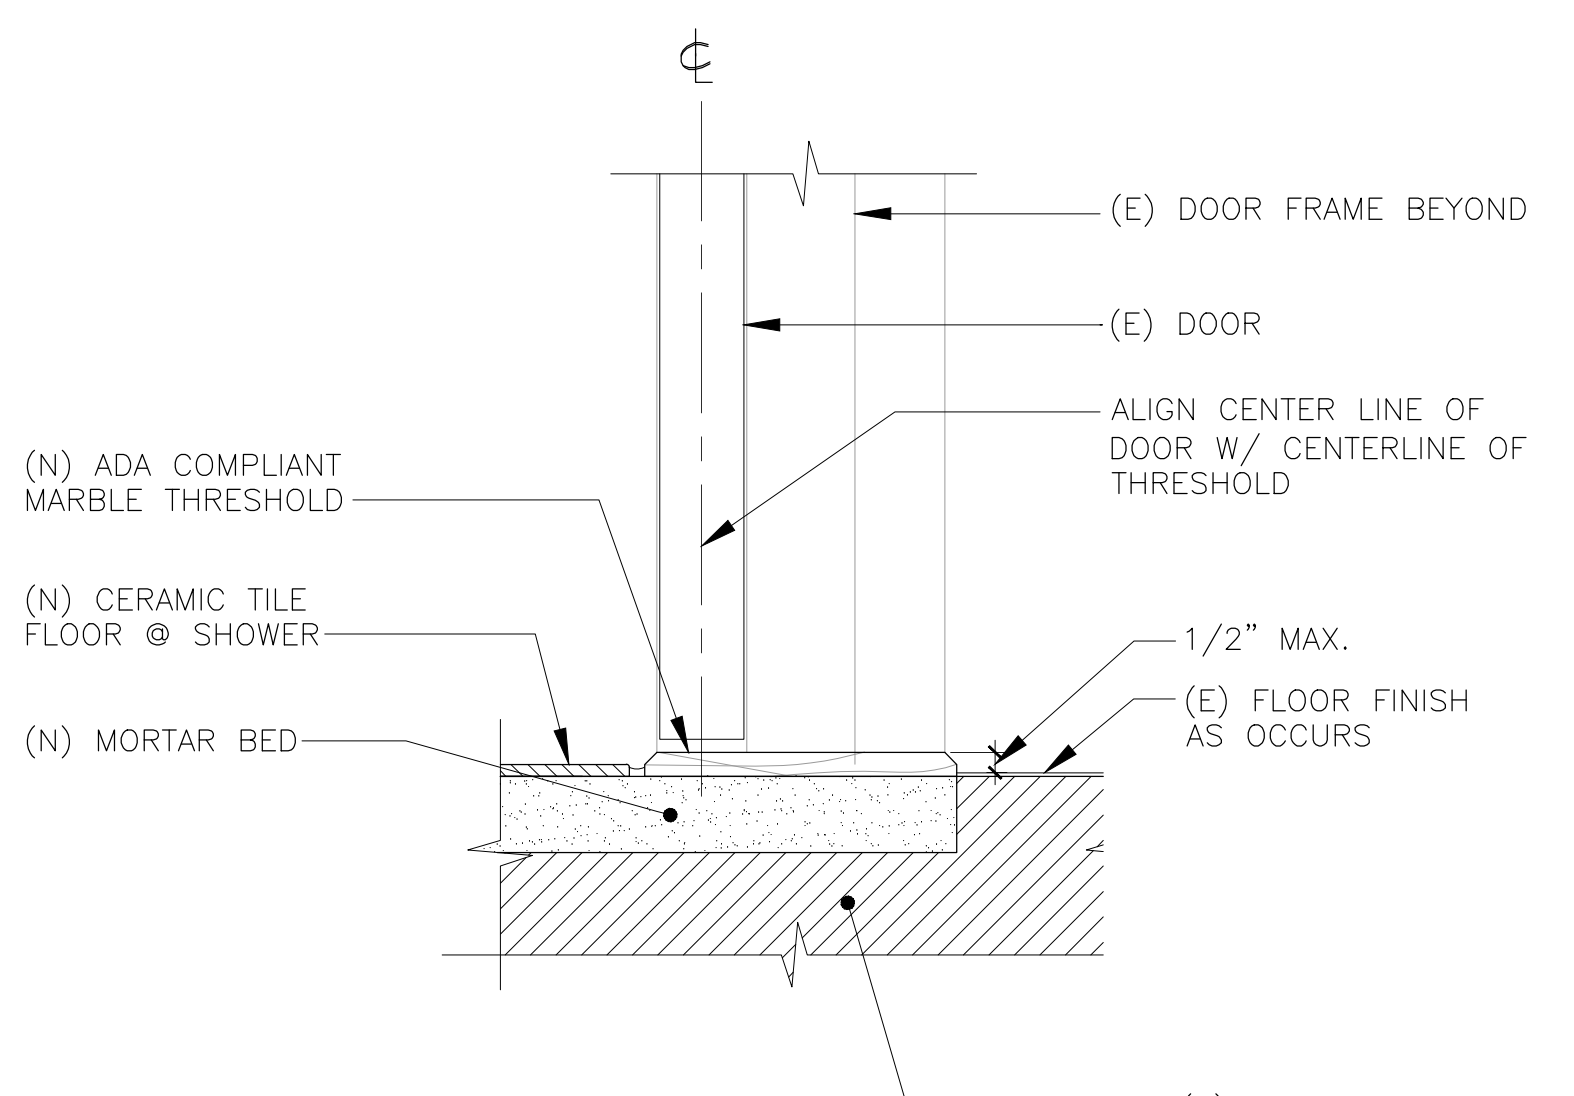

2 INTERIOR THRESHOLD SCALE: 3"=1'-0"

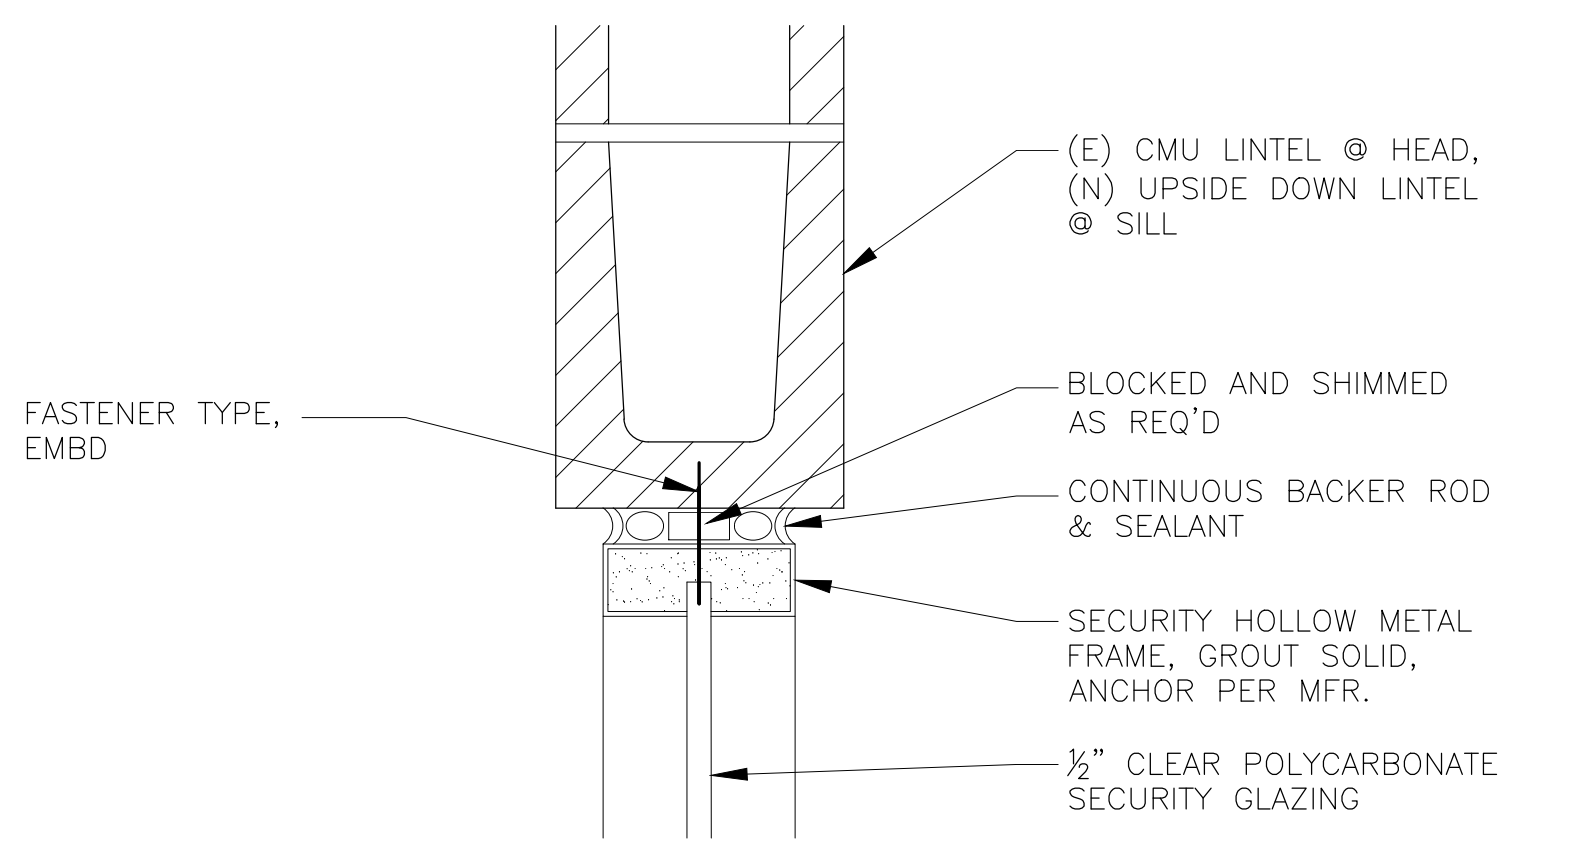


3 INTERIOR WINDOW HEAD JAMB, SILL SIM. SCALE: 3"=1'-0"

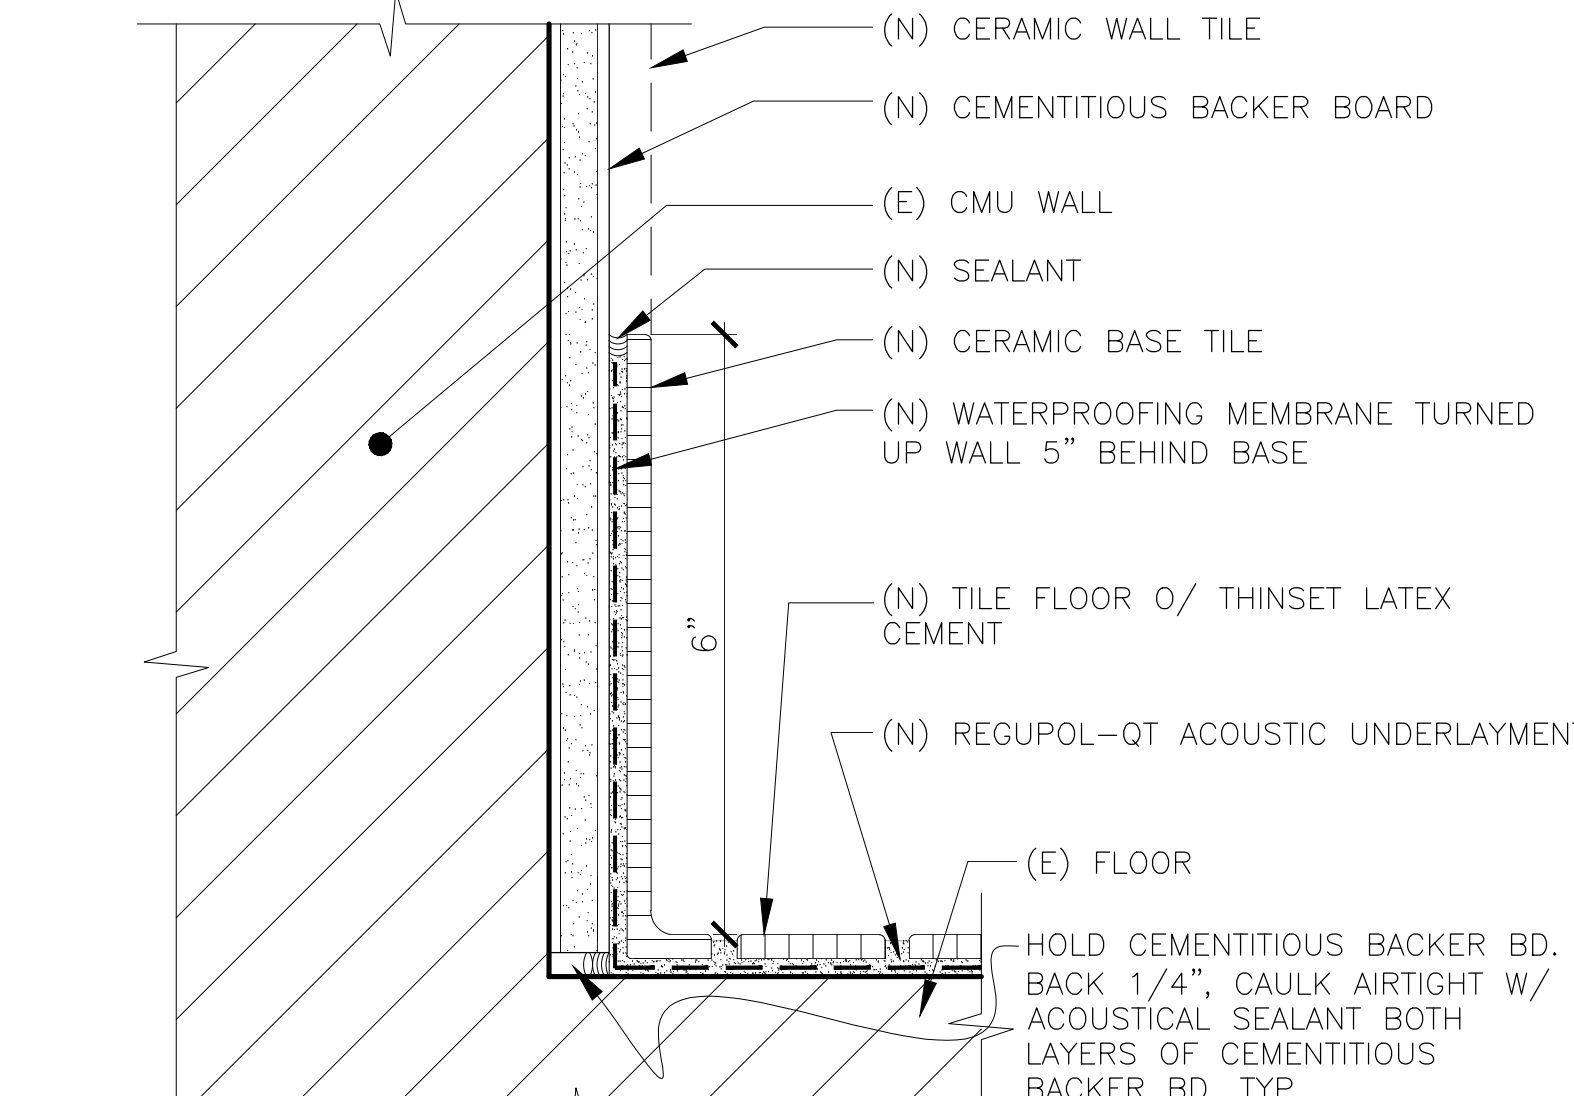

4 CERAMIC TILE SCALE: 6"=1'-0"

No.	DESCRIPTION	DATE
1	SCHEMATIC DESIGN	06-15-2020
2	60% DESIGN DOCUMENTS	07-10-2020
3	95% DESIGN DOCUMENTS	08-07-2020
4	100% DESIGN DOCUMENTS	09-04-2020
5	PLAN CHECK SUBMISSION	09-28-2020

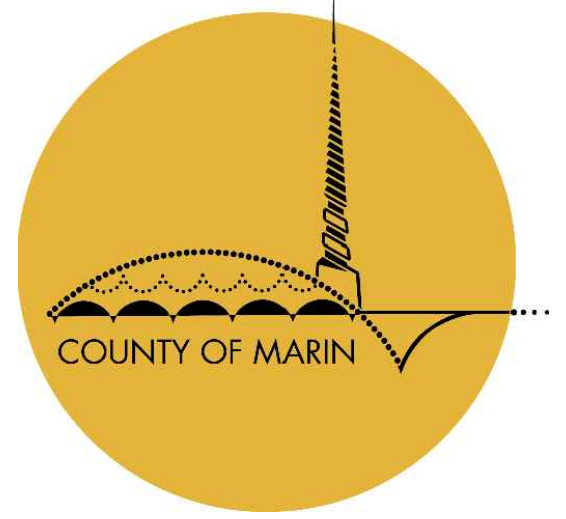

COUNTY OF MARIN, DEPARTMENT OF PUBLIC WORKS
PROJECT ACCEPTED BY:

Sally Swanson Architects, Inc.


SSA
500 Sansome St, Suite 410
San Francisco, CA 94111
Tel: 415.445.3045
Fax: 415.445.3055
ssa@swanarch.com

Architecture
Planning
Accessible Design

ARCHITECT STAMP
NOT APPROVED FOR CONSTRUCTION
DATE _____


PROJECT: MARIN COUNTY CORRECTIONAL FACILITY BOOKING AREA BARRIER REMOVAL PROJECT
13 PETER BEHR DRIVE SAN RAFAEL, CA 94903

DRAWING TITLE: **DETAILS**
SCALE: AS NOTED
JOB NUMBER: 20013.00
DRAWN BY: T.C.
CHECKED BY: K.W. & S.S.
DRAWING NUMBER: **A-3.1**
SHEET NO. _____ OF _____

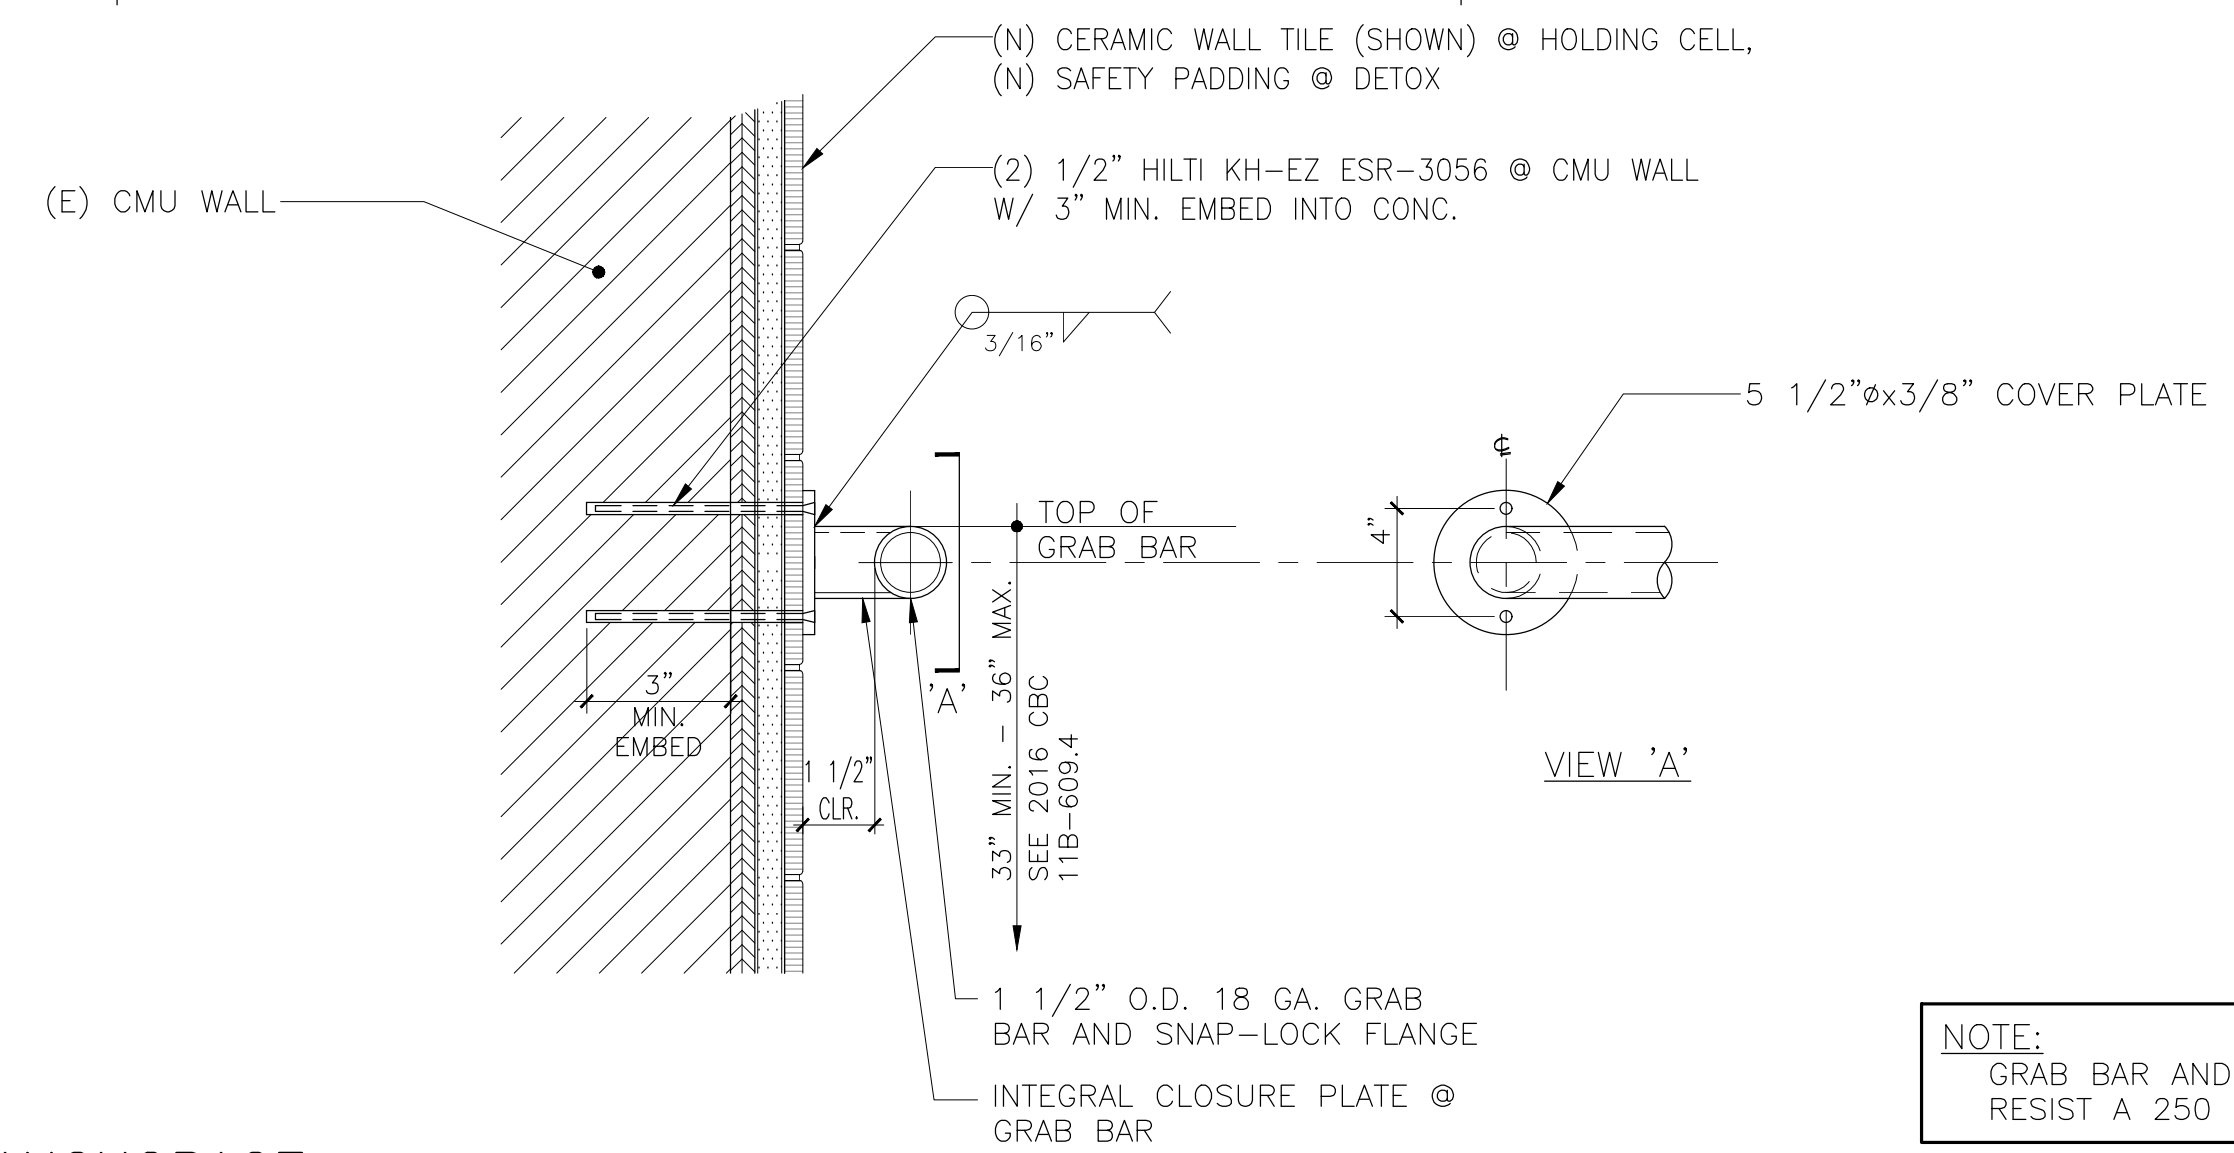


1 GRAB BAR ANCHORAGE

SCALE: 3/4"=1'-0"

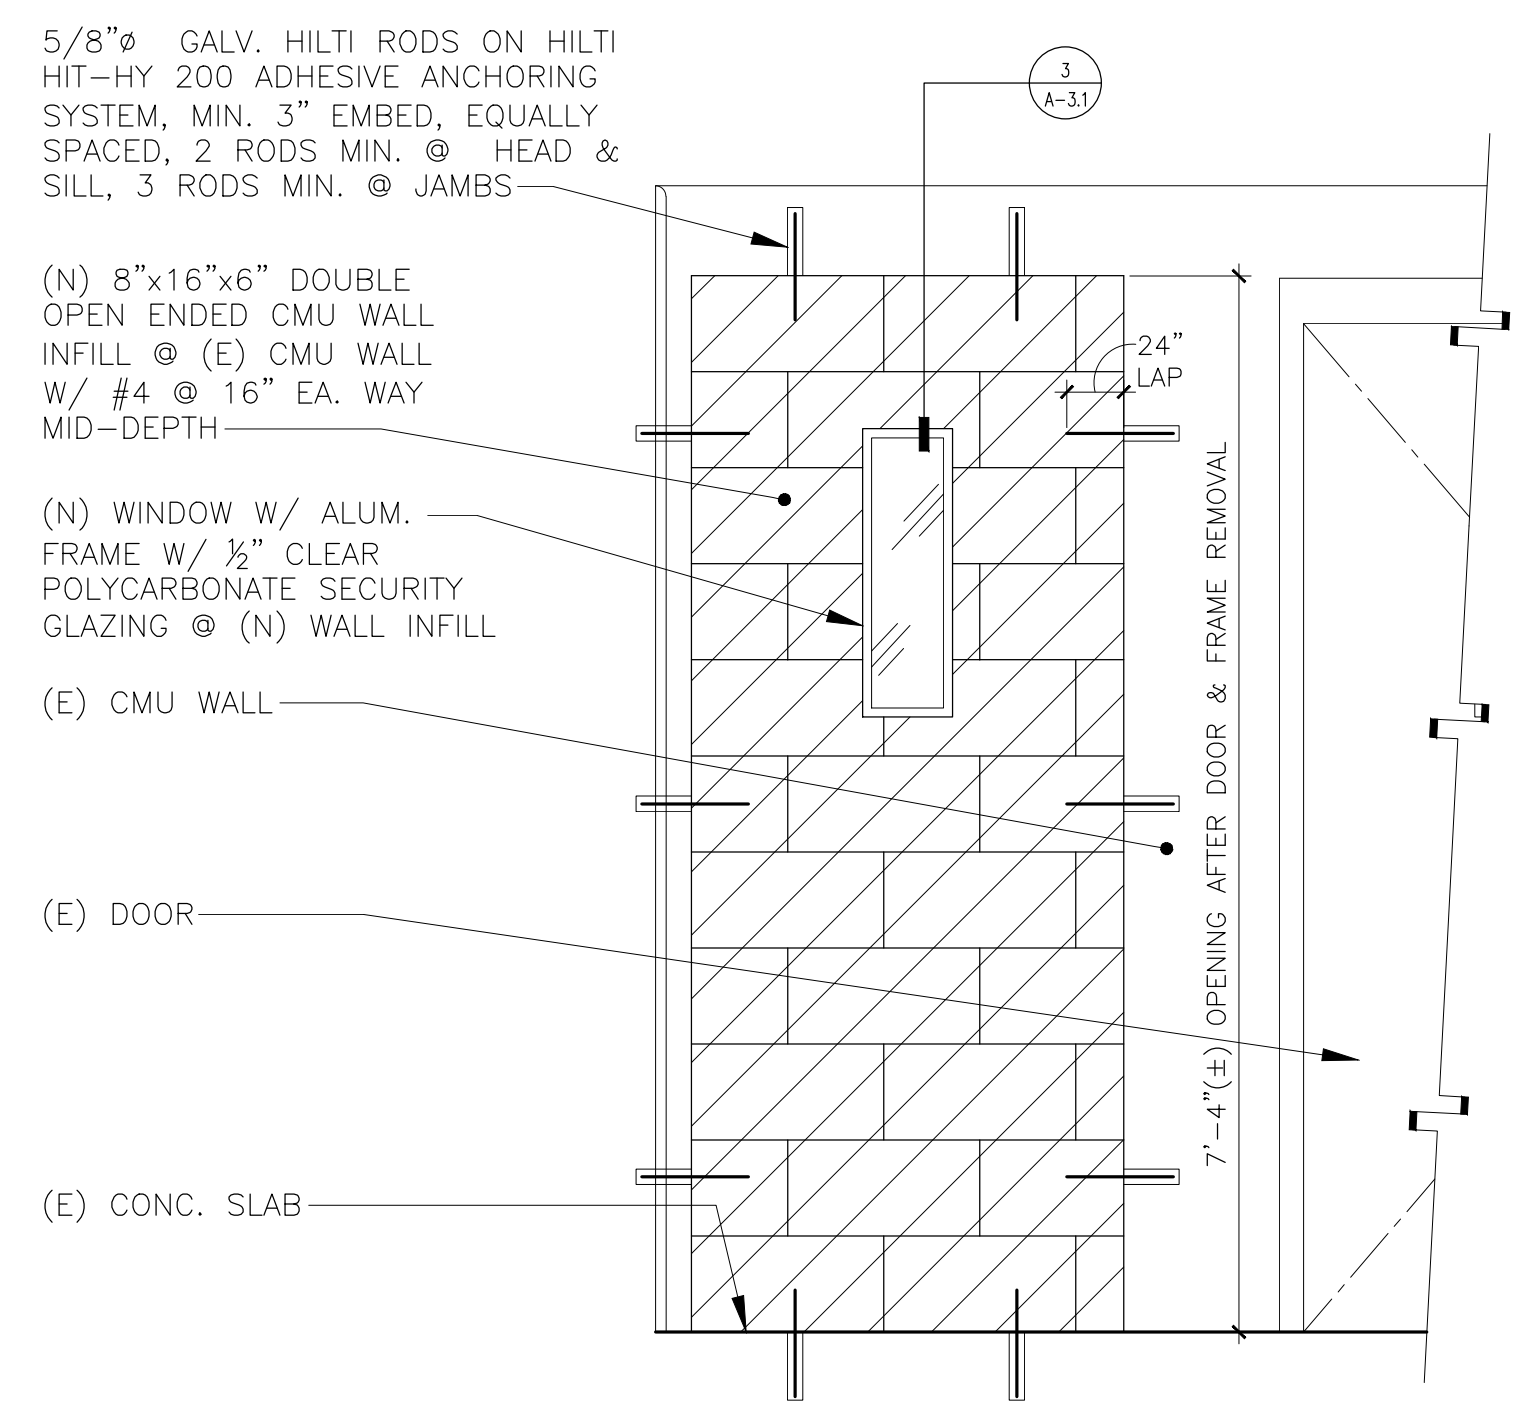

2 CMU WALL INFILL

SCALE: 3/4"=1'-0"

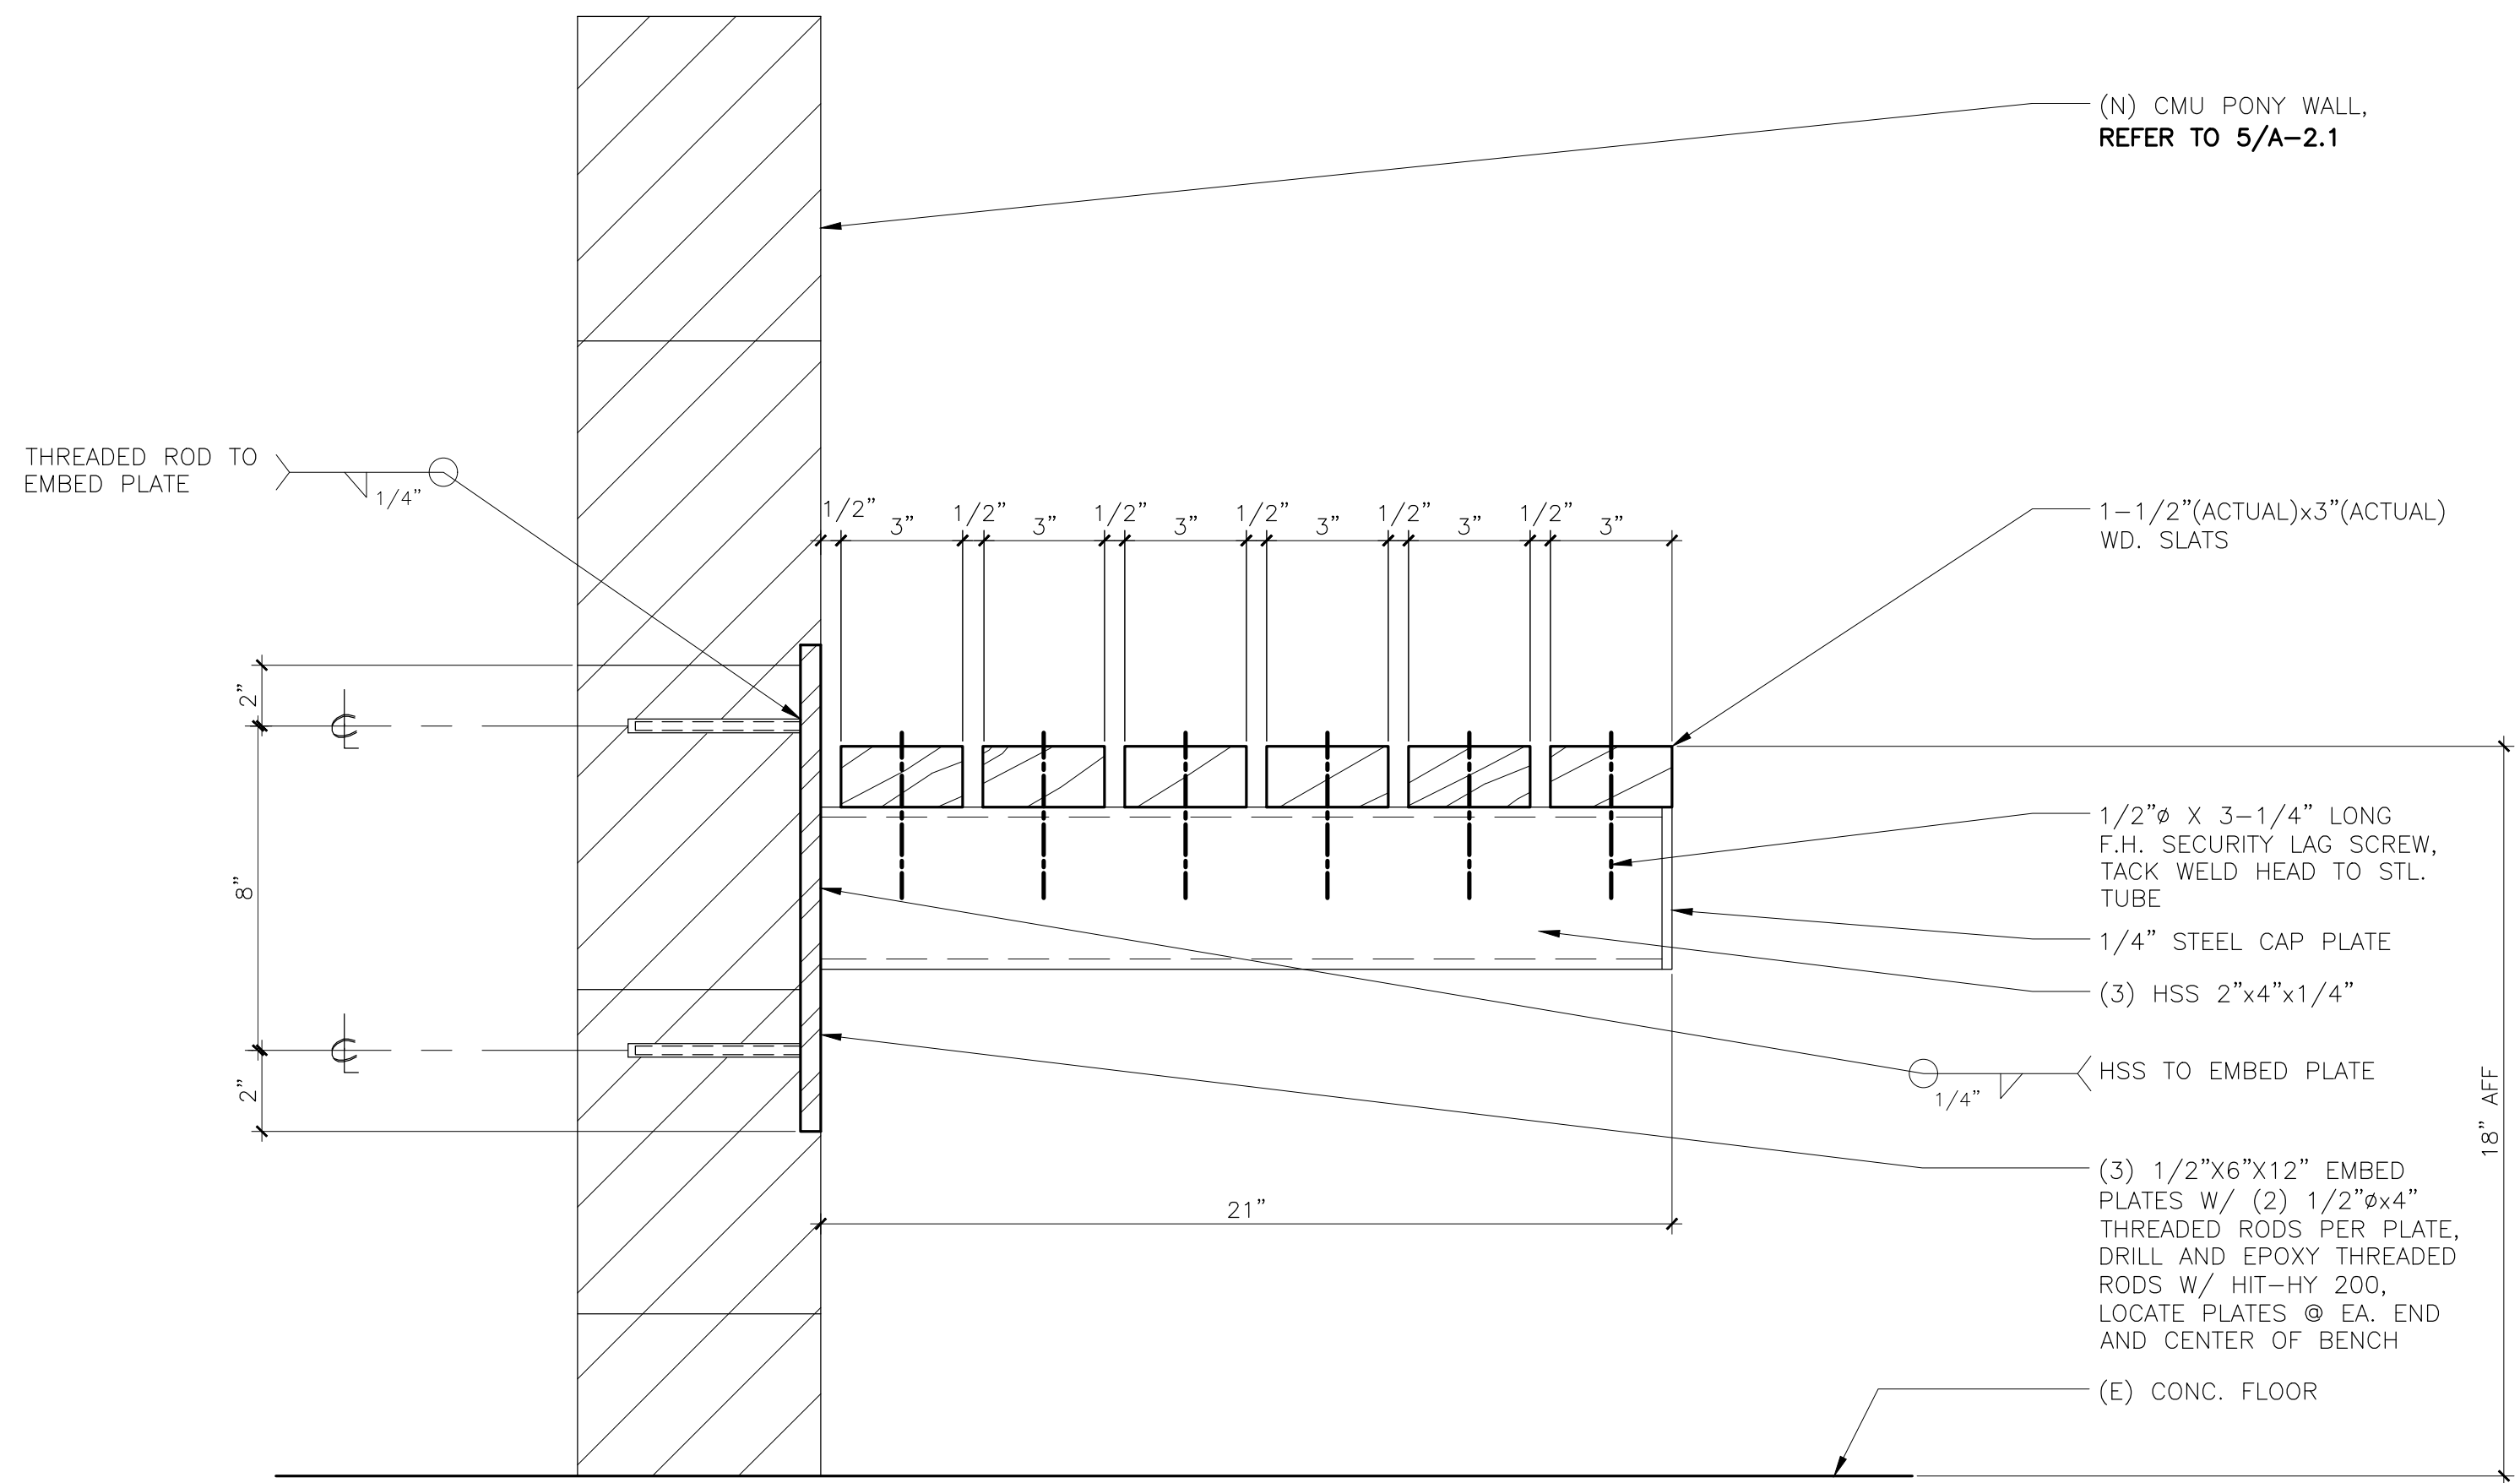

3 BENCH @ HOLDING CELL

SCALE: 3"=1'-0"

ISSUES/REVISIONS :

No.	DESCRIPTION	DATE
1	SCHEMATIC DESIGN	06-15-2020
2	60% DESIGN DOCUMENTS	07-10-2020
3	95% DESIGN DOCUMENTS	08-07-2020
4	100% DESIGN DOCUMENTS	09-04-2020
5	PLAN CHECK SUBMISSION	09-28-2020



COUNTY OF MARIN, DEPARTMENT OF PUBLIC WORKS
PROJECT ACCEPTED BY:

Sally Swanson Architects, Inc.

SSA
 500 Sansome St, Suite 410
 San Francisco, CA 94111
 Tel: 415.445.3045
 Fax: 415.445.3055
 ssa@swanarch.com

Architecture
 Planning
 Accessible Design

ARCHITECT STAMP

NOT APPROVED FOR CONSTRUCTION

DATE _____

PROJECT
 MARIN COUNTY
 CORRECTIONAL FACILITY
 BOOKING AREA
 BARRIER REMOVAL PROJECT

DRAWING TITLE
DETAILS

SCALE: AS NOTED

JOB NUMBER 20013.00	DRAWING NUMBER A-3.2
DRAWN BY T.C.	CHECKED BY K.W. & S.S.
SHEET NO. _____ OF _____	